

REV BY DATE

DESCRIPTION

THIS DRAWING IS THE CONFIDENTIAL PROPERTY AND CONTAINS TRADE SECRETS OF CELLXION, LLC. ANY USE OF THESE DRAWINGS OR THE INFORMATION CONTAINED HEREIN FOR ANY REASON OTHER THAN AS EXPRESSLY AUTHORIZED BY CELLXION, LLC. IS STRICTLY PROHIBITED. THIS DRAWING HAS BEEN DISTRIBUTED WITH THE UNDERSTANDING THAT ANYONE RECEIVING OR OTHERWISE OBTAINING POSSESSION OF IT WILL BE EXPRESSLY NOTIFIED OF ITS CONFIDENTIAL NATURE.



CUSTOMER:

TRITEL COMMUNICATIONS

PROJECT: 10'-0" X 16'-0" EQUIPMENT SHELTER COVER SHEET

FILENAME:	
ΠL20\ΠL200-0	
SCALE:	TOLERANCE:
N.T.S.	TOLLIVITOL.
DRWN, BY:	DATE:
V. HASSELL	11/10/99
CHK. BY:	DATE:
V. HASSELL	11/10/99
ENG. BY:	DATE:
K. BARNETT	11/10/99
APP. BY:	DATE:
M. MAYFIELD	11/10/99
SHEET NO.	
0-0	
DRAWING NO.:	

APP.BY DATE

STATE	CODE SUMMARY	USE GROUP	CONST. TYPE
ALABAMA	2003 INTERNATIONAL BUILDING CODE 2003 INTERNATIONAL MECHANICAL CODE 2003 INTERNATIONAL ENERGY CONSERVATION CODE 2005 NATIONAL ELECTRICAL CODE	S-2	V-B
ALASKA	2000 INTERNATIONAL BUILDING CODE 2000 INTERNATIONAL MECHANICAL CODE 2002 NATIONAL ELECTRICAL CODE	S-2	V-B
ARIZONA	2003 INTERNATIONAL BUILDING CODE 2003 INTERNATIONAL MECHANICAL CODE 2002 NATIONAL ELECTRICAL CODE	S-2	V-B
ARKANSAS	1997 STANDARD BUILDING CODE 1997 STANDARD MECHANICAL CODE 1999 NATIONAL ELECTRICAL CODE	S-2	VI-UNP
CALIFORNIA	1997 UNIFORM BUILDING CODE 1997 UNIFORM MECHANICAL CODE 1996 NATIONAL ELECTRICAL CODE CALIFORNIA TITLE 25	S-2	V-N
COLORADO	2003 INTERNATIONAL BUILDING CODE W/ MOD. 2003 INTERNATIONAL MECHANICAL CODE 2003 INTERNATIONAL ENERGY CONSERVATION CODE 2002 NATIONAL ELECTRICAL CODE	S-2	V-B
CONNECTICUT	1996 BOCA NATIONAL BUILDING CODE 1996 CT BASIC BUILDING CODE SUPPLEMENT 1996 INTERNATIONAL MECHANICAL CODE 1999 NATIONAL ELECTRICAL CODE	В	5B
DELAWARE	1996 BOCA NATIONAL BUILDING CODE 1996 BOCA MECHANICAL CODE 2002 NATIONAL ELECTRICAL CODE	В	5B
DISTRICT OF COLUMBIA	1996 BOCA NATIONAL BUILDING CODE 1996 INTERNATIONAL MECHANICAL CODE 1996 NATIONAL ELECTRICAL CODE	В	5B
FLORIDA	2004 FLORIDA BUILDING CODE W/ 2005 SUPPL. 2002 NATIONAL ELECTRICAL CODE	В	V-B
GEORGIA	2000 I.B.C. WITH 2002/03/04/05 GA AMENDS. 2000 I.M.C. WITH 2002/03/04/05 GA AMENDS. 2000 I.E.C.C. WITH GA AMENDMENTS 2005 NATIONAL ELECTRICAL CODE	S-2	VI-UNP
IDAHO	2003 INTERNATIONAL BUILDING CODE 2003 INTERNATIONAL MECHANICAL CODE 2002 NATIONAL ELECTRICAL CODE	S-2	V-B
ILLINOIS	1996 BOCA NATIONAL BUILDING CODE 1996 INTERNATIONAL MECHANICAL CODE 1999 NATIONAL ELECTRICAL CODE	В	5B
INDIANA	2000 INTERNATIONAL BUILDING CODE W/ AMEND. 2000 INTERNATIONAL MECH. CODE W/ AMEND. 2005 NATIONAL ELECTRICAL CODE	S-2	V-B
IOWA	2003 INTERNATIONAL BUILDING CODE 2003 INTERNATIONAL MECHANICAL CODE 2005 NATIONAL ELECTRICAL CODE 2004 INTERNATIONAL ENERGY CONS. CODE SUPPL.	S-2	V-N
KANSAS	1997 UNIFORM BUILDING CODE 1997 UNIFORM MECHANICAL CODE 1999 NATIONAL ELECTRICAL CODE	S-2	V-N
KENTUCKY	2002 KENTUCKY BUILDING CODE 2000 INTERNATIONAL MECHANICAL CODE 2002 NATIONAL ELECTRICAL CODE	В	5B

- THIS SHELTER NOT INTENDED FOR HUMAN HABITATION
- OCCUPANT LOAD = 0, OHIO = 2
- SPECIAL CONDITIONS: N/A
- PERMISSIBLE TYPES OF GASES: N/A
 SHELTER IS DESIGNED TO MEET HIGHER SNOW AND WIND LOADS. SHELTER HAS NO COUNTY PLACEMENT RESTRICTION IN THE STATE OF MARYLAND.
- STATE INSIGNIA LABEL/DECAL IS LOCATED NEAR MAIN ELECTRICAL SERVICE PANEL. DOOR MUST BE MINIMUM 90 MINUTE FIRE RATED IF USED IN 2 HOUR FIRE RATED
- ENERGY CODE EVALUATION BASE ON 2000 INTERNATIONAL ENERGY CONSERVATION
- CODE WITH 2001 SUPPLEMENT.

 NOT SUBJECT TO FLORIDA FIRE SAFETY CODE.

 SHELTER HAS BEEN DESIGNED IN ACCORDANCE WITH THE CITY OF CHICAGO MUNICIPAL
- ACCESS TO SHELTER SHALL COMPLY WITH MARYLAND ACCESSIBILITY CODE COMAR .05.02.02.07/ADAAG SECTION 4.1.2.
- 12. ALL WELDS SHALL BE VERIFIED BY SPECIAL INSPECTION SHOWING CONFORMANCE TO THE DESIGN DRAWINGS AND SPECIFICATIONS.

CTATE	CODE CUMMARY	USE	CONST.
STATE	CODE SUMMARY	GROUP	TYPE
LOUISIANA	2000 INTERNATIONAL BUILDING CODE 2000 INTERNATIONAL MECHANICAL CODE 1999 NATIONAL ELECTRICAL CODE	S-2	V-B
MAINE	1996 BOCA NATIONAL BUILDING CODE 1996 BOCA MECHANICAL CODE 1999 NATIONAL ELECTRICAL CODE	В	5B
MARYLAND	2003 INTERNATIONAL BUILDING CODE W/ MOD. 2003 INTERNATIONAL MECHANICAL CODE 2003 INTERNATIONAL PLUMBING CODE 2002 NATIONAL ELECTRICAL CODE 2002 MARYLAND ACCESSIBILITY CODE 2000 NFPA 101 LIFE SAFETY CODE W/ AMD.	S-2	V-B
MASSACHUSETTS	6TH MA STANDARD BUILDING CODE 2005 MA ELECTRICAL CODE	S-2	V-B
MICHIGAN	2003 MICHIGAN BUILDING CODE 2003 MICHIGAN MECHANICAL CODE 2002 NATIONAL ELECTRICAL CODE	U	V-B
MINNESOTA	2003 MN STATE BLDG CODE (2000 IBC W/AMEND. 2003 MN STATE MECHANICAL CODE (CHAPTER 1346-2000 IMC & 2000 IFGC W/AMEND.) 2003 MN STATE PLUMBING CODE (CHAPTER 4715) 2000 MN ENERGY CODE (CHAPTER 7674, 7676, 7 1998 MN ACCESSIBILITY CODE (CHAPTER 1341)	3-2	V-B
. wooloolbbi	2005 NATIONAL ELECTRICAL CODE		
MISSISSIPPI	2000 INTERNATIONAL BUILDING CODE 2000 INTERNATIONAL MECHANICAL CODE 2002 NATIONAL ELECTRICAL CODE	S-2	V-B
MISSOURI	2000 INTERNATIONAL BUILDING CODE 2000 INTERNATIONAL MECHANICAL CODE 1999 NATIONAL ELECTRICAL CODE	S-2	V-B
MONTANA	2000 INTERNATIONAL BUILDING CODE 2000 INTERNATIONAL MECHANICAL CODE 1999 NATIONAL ELECTRICAL CODE	S-2	V-B
NEBRASKA	2000 INTERNATIONAL BUILDING CODE 2000 INTERNATIONAL MECHANICAL CODE 2005 NATIONAL ELECTRICAL CODE	S-2	V-B
NEVADA	2003 INTERNATIONAL BUILDING CODE 2000 INTERNATIONAL BUILDING CODE 1997 UNIFORM BUILDING CODE 2003 INTERNATIONAL MECHANICAL CODE 2000 INTERNATIONAL MECHANICAL CODE 1997 UNIFORM MECHANICAL CODE 1996 NATIONAL ELECTRICAL CODE 2002 NATIONAL ELECTRICAL CODE	S-2 S-2 S-2	V-B V-B V-N
NEW HAMPSHIRE	2000 INTERNATIONAL BUILDING CODE 2000 INTERNATIONAL MECHANICAL CODE 2005 NATIONAL ELECTRICAL CODE	В	5B
NEW JERSEY	2000 INTERNATIONAL BUILDING CODE AS AMENDED 2000 INTERNATIONAL MECH. CODE W/ NJ AMEND. 2002 NATIONAL ELECTRICAL CODE AS AMENDED 1995 CABO MODEL ENERGY CODE W/ NJ AMEND.	S-2	V-B
NEW MEXICO	2003 NEW MEXICO COMMERCIAL BUILDING CODE 2003 NEW MEXICO MECHANICAL CODE 2003 NEW MEXICO ELECTRICAL CODE	В	5B
NEW YORK	2002 BUILDING CODE OF NEW YORK STATE 2002 MECHANICAL CODE OF NEW YORK STATE 2002 ELECTRICAL CODE OF NEW YORK STATE	S-2	V-B
NORTH CAROLINA	2002 NORTH CAROLINA BUILDING CODE 2002 NORTH CAROLINA MECHANICAL CODE 2005 NORTH CAROLINA ELECTRICAL CODE	S-2	V-B

- 13. BUILDING CATEGORY II (PER ASCE TABLE 1-1).
- 14. APPLICABLE INTERNAL PRESSURE COEFFICIENT (NOT APPLICABLE) THESE SHELTERS CONFORM TO THE REQUIREMENTS OF SECTION 1606.2 "SIMPLIFIÉD PROVISIONS FOR LOW RISE BUILDINGS
- 15. WIND IMPORTANCE FACTOR IW = 1.00
- 16. THIS SHELTER IS AN "ENCLOSED STRUCTURE."
- 17. EXTERIOR COMPONENTS AND CLADDING POSITIVE AND NEGATIVE PRESSURES IN TERMS OF PSF - SEE TABLE BELOW:

ROOF ZONE 1: 18.9 (100 SF EFFECTIVE WIND AREA) ROOF ZONE 2: 21.8 -88.5 (20 SF EFFECTIVE WIND AREA) -147.9 (10 SF EFFECTIVE WIND AREA) ROOF ZONE 3: 23.2 -55.1 (200 SF EFFECTIVE WIND AREA) WALL ZONE 4: 49.3

WALL ZONE 5: 55.1 -72.5 (30 SF EFFECTIVE WIND AREA)

THESE PLANS ARE DESIGNED TO BE USED FOR THE CONSTRUCTION OF COMMERCIAL

MODULAR UNITS, IN ACCORDANCE WITH CA HEALTH AND SAFETY CODE SECTION 18028 MRC 4/19/02 UPDATED DRAWING WITH X-REF 1991 UBC, 1993 NEC, ANSI A117.1-1986.

	2003 INTERNATIONAL ENERGY CONSERVATION CODE 2005 NATIONAL ELECTRICAL CODE		
OHIO	2005 OHIO BUILDING CODE 2005 OHIO MECHANICAL CODE 2005 NATIONAL ELECTRICAL CODE	S-2	5B
OKLAHOMA	2003 INTERNATIONAL BUILDING CODE 2003 INTERNATIONAL MECHANICAL CODE 2002 NATIONAL ELECTRICAL CODE	S-2	V-B
OREGON	2003 INTERNATIONAL BLDG. CODE W/ AMEND. 2003 INTERNATIONAL MECH. CODE W/ AMEND. 2002 NATIONAL ELECTRICAL CODE 2004 OREGON STRUCTURAL SPECIALTY CODE	S-2	V-B
PENNSYLVANIA	2003 INTERNATIONAL BUILDING CODE 2003 INTERNATIONAL MECHANICAL CODE 2005 NATIONAL ELECTRICAL CODE	S-2	V-B
RHODE ISLAND	2003 IBC WITH RHODE ISLAND AMENDMENTS 2003 IMC WITH RHODE ISLAND AMENDMENTS 2003 IECC WITH RHODE ISLAND AMENDMENTS 2002 NATIONAL ELECTRICAL CODE	S-2	V-B
SOUTH CAROLINA	2003 INTERNATIONAL BUILDING CODE 2003 INTERNATIONAL MECHANICAL CODE 2002 NATIONAL ELECTRICAL CODE	S-2	V-B
SOUTH DAKOTA	2000 INTERNATIONAL BUILDING CODE 2000 INTERNATIONAL MECHANICAL CODE 2002 NATIONAL ELECTRICAL CODE	S-2	V-B
TENNESSEE	2003 INTERNATIONAL BUILDING CODE (IBC) 2003 INTERNATIONAL MECHANICAL CODE (IMC) 2002 NATIONAL ELECTRICAL CODE (NEC) 2003 IECC	S-2	VI-UNP
TEXAS	2003 INTERNATIONAL BUILDING CODE 2003 INTERNATIONAL MECHANICAL CODE 2003 IECC 2002 NATIONAL ELECTRICAL CODE	S-2	V-B
UTAH	1997 UNIFORM BUILDING CODE 1998 INTERNATIONAL MECHANICAL CODE 1999 NATIONAL ELECTRICAL CODE	S-2	V-N
VERMONT	1996 BOCA NATIONAL BUILDING CODE 1996 BOCA NATIONAL MECHANICAL CODE 1996 NATIONAL ELECTRICAL CODE	В	5B
VIRGINIA	2003 INTERNATIONAL BUILDING CODE 2003 INTERNATIONAL MECHANICAL CODE 2002 NATIONAL ELECTRICAL CODE	В	5B
WASHINGTON	2003 INTERNATIONAL BUILDING CODE W/ AMEND. 2003 INTERNATIONAL MECH. CODE W/ AMEND. 2002 NATIONAL ELECTRICAL CODE	В	5B
WEST VIRGINIA	2000 INTERNATIONAL BUILDING CODE 2000 INTERNATIONAL MECH. CODE 2002 NATIONAL ELECTRICAL CODE	S-2	V-B
WISCONSIN	2000 INTERNATIONAL BUILDING CODE W/ AMEND. 2000 INTERNATIONAL MECH. CODE W/ AMEND. 1999 NATIONAL ELECTRICAL CODE	S-2	V-B
WYOMING	1997 UNIFORM BUILDING CODE 1997 UNIFORM MECHANICAL CODE 1999 NATIONAL ELECTRICAL CODE	S-2	V-N

CODE SUMMARY

2003 INTERNATIONAL BUILDING CODE 2003 INTERNATIONAL MECHANICAL CODE

STATE

NORTH DAKOTA

USE

S-2

GROUP

CONST.

TYPE

V-B

	I hereby certify that this engineering document was prepared by me or my direct supervision and that I am a duly licensed professional Engineer under the laws of the State of Iowa.
SEAL	signature date Printed or typed name
	My license renewal date is December 31, Pages or sheets covered by my seal:
/10 /02 LIDDATED DRAWING	Date issued:

DESCRIPTION

R MRC 8/27/01 UPDATED TO NEW DRAWING STANDARD

P CTF 2/22/01 UPDATED PER NEW DWG. STANDARDS

REV BY DATE

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CUSTOMER: TRITEL COMMUNICATIONS

PROJECT: 10'-0" X 16'-0" EQUIPMENT SHELTER CODE SUMMARY

FILENAME: TTL20\TTL200-1		
SCALE:	TOLERAN	CE:
N.T.S. DRWN. BY: S. MARTIN	DATE:	. /00
CHK. BY:	DATE:	/00
V. HASSELL ENG. BY:	3/3 DATE:	
K. BARNETT APP. BY:	3/3 DATE:	
M. MAYFIELD SHEET NO.	3/3	/00
0-1		
DRAWING NO.:		-
STTL20		/

VGH 8/27/01

VGH 2/22/01

APP.BY DATE

ITEM LIST

NO.	QTY	U/M	PART NO.	DESCRIPTION
1	1	ĒA.	430250	COMBINATION PANEL, TVSS, LOADCENTER, TRANSFER SWITCH, 200A, NORTHERN TECH.
2	1	EA.	520122	HVAC #1, 2 TON, 2.5 KW, EUBANK WITH GRILLES & HARD START KIT
3	1	EA.	520123	HVAC #2, 2 TON, 7 KW, EUBANK WITH GRILLES
4	1	EA.	430242	GENERATOR RECEPTACLE, 200A, CROUSE HINDS, AR2041 S22
5	1	EA.	490000	MAGNETIC DOOR ALARM
6	1	EA.	470005	EXTERIOR LIGHT FIXTURE, 70HPS, WALL MOUNT, 30 MIN. TIMER
7	1	EA.	500009	DOOR, 3670, LH, 18 GA, HALLOW METAL WITH DOOR FRAME ASSEMBLY
8	5	EA.	170004	GROUND PENETRATIONS, 1 1/4" SCH 40 PVC CAST @ 45°
9	1	EA.	410181	SERVICE ENTRY, 2" X 9" GALVANIZED RIGID CONDUIT NIPPLE WITH 2" LB
10	1	EA.	504508	LOCK SET, ELECTRONIC, SARGENT, 72-KP10G-77 W/ BEST CORE
11	1	EA.	430033	GFCI RECEPTACLE, 20A WITH WP BOX
12	2	EA.	410182	PENETRATION RIGID NIPPLE, 3/4" X 8 1/2", GALVANIZED, CAPPED WEATHER TIGHT
13	5	EA.	430005	JUNCTION BOX, 4"X 4"
14	2	EA.	410182	JUNCTION BOX, 4" X 4" WITH 3/4" X 8 1/2" GALV. RIGID NIPPLE
15	2	EA.	410229	JUNCTION BOX, 4 11/16" X 4 11/16" WITH 1" X 8 1/2" GALV. RIGID NIPPLE
16	1	EA.	430084	SWITCH, 1P1T, 20A WITH 4" X 4" JB (INTERIOR LIGHTS)
17	1	EA.	430075	ALARM BLOCK, 66 TERMINAL, S66M150
18	1	EA.	460101	HIGH TEMPERATURE ALARM. DAYTON 2E206
19	1	EA.	460101	LOW TEMPERATURE ALARM, DAYTON 2E206
20	1	EA.	460104	LEAD/ LAG CONTROLLER, EUBANK, LLC
21	100	FT.	400050	HALO RING AND DROPS, #2 STRANDED GREEN COPPER
22	2	EA.	430034	QUAD RECEPTACLE, 20A WITH 4" X 4" JB
23	1	EA.	540127	GROUND BAR, 4" X 20" X 1/4", COPPER W/ 7/16"ø HOLES
24	4	EA.	470057	INTERIOR LIGHT FIXTURE, 4', DUAL BULB FLUORESCENT, T8, W/BULB P/N 470058
25	1	EA.	490011	SMOKE DETECTOR, 120V, ION
26	40	FT.	510000	CABLE TRAY, 12", GOLD CHROMATE
27	2	EA.	510003	WALL SUPPORT ANGLE, 12" CABLE TRAY
28	10	EA.	510069	CABLE TRAY HANGER ASSMBLY, 12" CABLE TRAY
29	4	EA.	510003	CABLE LADDER WALL "S" CLAMP
30	VARIES	FT.	400030	JUMPERS, #6 STRANDED GROUND WIRE COPPER
31	3	EA.	410201	JUNCTION BOX, 4" X 4" WITH 1/2" X 8 1/2" GALV. RIGID CONDUIT NIPPLE THRU WALL
32	1	EA.	410201	1/2" X 8 1/2" GALVANIZED RIGID CONDUIT NIPPLE
33			350002	TELCO BOARD, 4'-0" X 4'-0"
34	2	EA.		ENCLOSURE, 6" X 6" X4", NEMA 1
		EA.	430008	
35	1	EA.	400536	RELAY, POWER FAIL, DPDT, 10A, 240V,
36	1	EA.	390014	FIRE EXTINGUISHER, 10 LB, ABC RATED
37	40	FT.	400099	HALO COILS, #2 BARE SOLID TINNED COPPER WIRE
38	18	EA.	470018	COMPRESSION "C" TAP, BURNDY
39	1	EA.	470018	TIMER, EXTERIOR LIGHT, 60 MIN., WITH 4" X 4" JB
40	2	EA.	410096	EMT CONNECTOR, 1/2", WITH PLASTIC BUSHING
41	1	EA.	530017	WAVEGUIDE ENTRY PORT, ROXTEC G8X1
42	1	EA.	530016	BLANK WAVEGUIDE PLATE, 8" X 16" X 1/8", PAINTED TO MATCH TRIM
43	2	EA.	410019	CONDULET, LB, 1"
44	6	FT	400032	#12 GREEN INSULATED STRANDED COPPER WIRE
45	1	EA.	430173	3/4" PIPE CAP
46	2	EA.	430172	1" PLUG
47	1	EA.	430053	2" PLUG
48	1	EA.	400009	1" X 12" GROUNDING STRAP
49	4	EA.	430029	JUNCTION BOX, 4 11/16" X 4 11/16"
50	1	EA.	430034	QUAD RECEPTACLE, 20A WITH 4" X 4" JB
51	1	EA.	410207	JUNCTION BOX 4" X 4" W/ 1/2" X 8" RIGID NIPPLE

S	MRC	4/19/02	UPDATED ITEMS 7, & 24 PART NO. AND ADDED # 50	VGH	4/19/02
R	MRC	8/28/01	REVISED PER MARKUP'S	VGH	8/28/01
М	CTF	11/07/00	CHG'D ITEMS DESCRITIONS 30, 48, & 49	VGH	11/07/00
L	CTF	10/18/00	CHG'D ITEMS DESCRITIONS 8, 10, & 23	VGH	10/18/00
J	MRC	6/23/00	CHG'D ITEMS DESCRITIONS 4 & 10	VGH	6/23/00
	MRC	6/15/00	ADDED 45 46 47 & CHG'D 10	VGH	6/15/00
H	GE	4/10/00	CHG'D.: ITEM #44 WAS #16 SOLID WIRE; REMV'D. ITEM 5 &		
			30; ITEMS #41 AND #42 WERE QTY. OF 2 EA.		
Ε	SM	3/4/00	ADDED ITEM #44	VGH	3/4/00
В	VGH	12/28/99	CHANGES MADE PER PROTOTYPE REVIEW BY CUSTOMER	VGH	12/28/99
Α	GE	12/28/99	CHG'D: ITEM 4 WAS HUBBELL BRAND; ITEM 12 WAS QTY. OF	VGH	12/28/99
			4. ADDED: "30 MIN. TIMER" TO ITEM 6		
REV	BY	DATE	DESCRIPTION	APP.BY	DATE

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CUSTOMER:

TRITEL COMMUNICATIONS

PROJECT: 10'-0" X 16'-0" EQUIPMENT SHELTER ITEM LIST

FILENAME:	
TTL020\TTL200-	2
SCALE:	TOLERANCE:
N.T.S.	
DRWN. BY:	DATE:
V. HASSELL	11/10/99
CHK. BY:	DATE:
V. HASSELL	11/10/99
ENG. BY:	DATE:
K. BARNETT	11/10/99
APP. BY:	DATE:
M. MAYFIELD	11/10/99
SHEET NO.	
0-2	
, ,	
DRAWING NO.:	
STTI 20	l T
	-

DOOR HARDWARE SCHEDULE

QTY	U/M	PART NO.	_ DESCRIPTION
3	EA.	504000	DOOR HYNGES, 35
1	EA.	504100 V	CLOSER, SARGENT 1104, ALUM.
1	EA. (504113	HOLD OPEN, T-LATCH, 6" SS
1	EA.	504102	BUMPER, RUBBER STOP, BROWN
1	SET	504200 🔨	WEATHER STRIPPING, MACNETIC
1	EA.	504201	SWEEP, WEATHER STRIPPING, 42"
1	EA.	504300	LOCKGUARD, 10", SS
1	SET	504401	THRESHOLD, 48", 2 PCS, ALUMIMUM
1	EA.	504503	PULL HANDLE, CHROME
	•		

FINISH SCHEDULE

EXTERIOR			
	WALLS		EXPOSED AGGREGATE
	ROOF		LATEX ROOF COATING
	METALS		PPG, URETEK PAINT, CUSTOM COLOR MATCH
INTERIOR			
	WALLS		
		INSULATION	1 1/2" R-MAX TSX8500
		WOOD	7/16" OSB SHEATHING
		EXPOSED	3/8" FRP
	CEILING		
		INSULATION	2" R-MAX TSX8500
		WOOD	7/16" OSB SHEATHING
		EXPOSED	3/8" FRP
	FLOOR		
		EXPOSED	.100 VINYL TILE, CONGOLEUM CX-14, COLOR "WHITE/LIGHT PEBBLE"

PACKING LIST (ITEMS THAT ARE TO BE SHIIPPED INSIDE SHELTER)

QTY	U/M	PART NO.	DESCRIPTION
2	EA.	220206	LIFTING BRACKET, RH
2	EA.	220207	LIFTING BRACKET, LH
8	EA.	168044	BOLT, 1" X 2 1/2" HEX
8	EA.	168045	WASHER, 1" FLAT
4	EA.	693020	TIE DOWN ANGLE, 4" X 4" X 12"
4	EA.	693018	TIE DOWN PLATE, 12" X 12"
8	EA.	168056	CONCRETE ANCHOR, 3/4" X 4 1/2", COIL
8	EA.	490034	SHIM, 2" X 4" X 1/4", KOROLATH
VARIES	EA.	VARIES	LIGHT FIXTURE, EXTERIOR, (SIDE WALL MOUNTED)
VARIES	EA.	VARIES	ANY EXTERIOR SIDE MOUNT FIXTURE REMOVE FOR SHIPPING

BREAKER SCHEDULE

QTY	U/M	PART NO.	DESCRIPTION
1	EA.	400154	BREAKER, CH, 1P, 15A, BOLT ON, BAB1015
3	EA.	400172	BREAKER, CH, 1P, 20A, BOLT ON, BAB1020
10	EA.	400100	BREAKER, CH, 2P, 20A, BOLT ON, BAB2020
1	EA.	400590	BREAKER, CH, 2P, 40A, BOLT ON, BAB2040
1	EA.	400159	BREAKER, CH, 2P, 60A, BOLT ON, BAB2060
	EA.		

REV BY DATE DESCRIPTION APP.BY DATE	S	SM	4/18/02	ADDED SHEET TO SET AND CHG'D T-LATCH TO 6"	VGH	4/18/02	
	REV	ΒY	DATE	DESCRIPTION	APP.BY	DATE	ll

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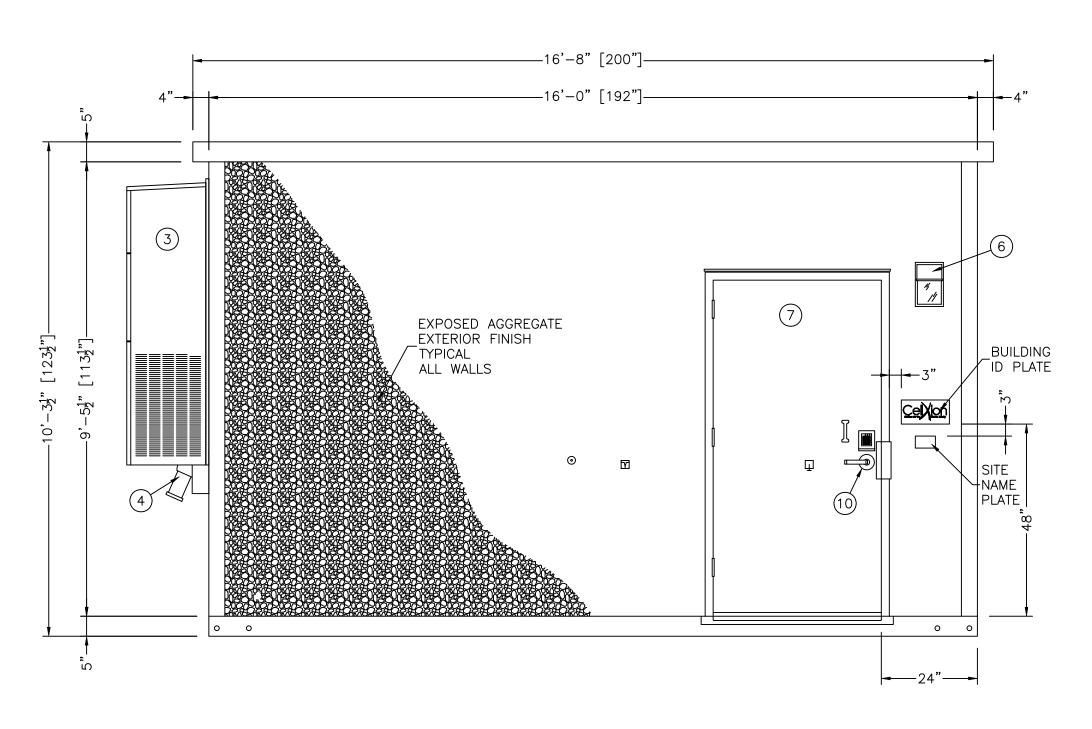


CUSTOMER:

TRITEL COMMUNICATIONS

PROJECT: 10'-0" X 16'-0" EQUIPMENT SHELTER ITEM LIST

FILENAME:						
TTL020\TTL200-3						
SCALE:	TOLERANCE:					
N.T.S.						
DRWN. BY:	DATE:					
M. CROW	4/19/02					
CHK. BY:	DATE:					
V. HASSELL	4/19/02					
ENG. BY:	DATE:					
K. BARNETT	4/19/02					
APP. BY:	DATE:					
M. MAYFIELD	4/19/02					
SHEET NO.						
03						
DRAWING NO.:						



EXTERIOR ELEVATION "A"

Q	CTF	3/7/01	CORRECTED TITLE BLOCK	VGH	3/7/01
1	MRC	6/14/00	REMOVED LOCK SET AND ADDED SARGENT	VGH	6/14/00
С	SM	2/1/00	ADDED SITE NAME PLATE	VGH	2/1/00
В	SM	1/06/00	REMOVED FLOATING ITEM NUMBER	VGH	1/06/00
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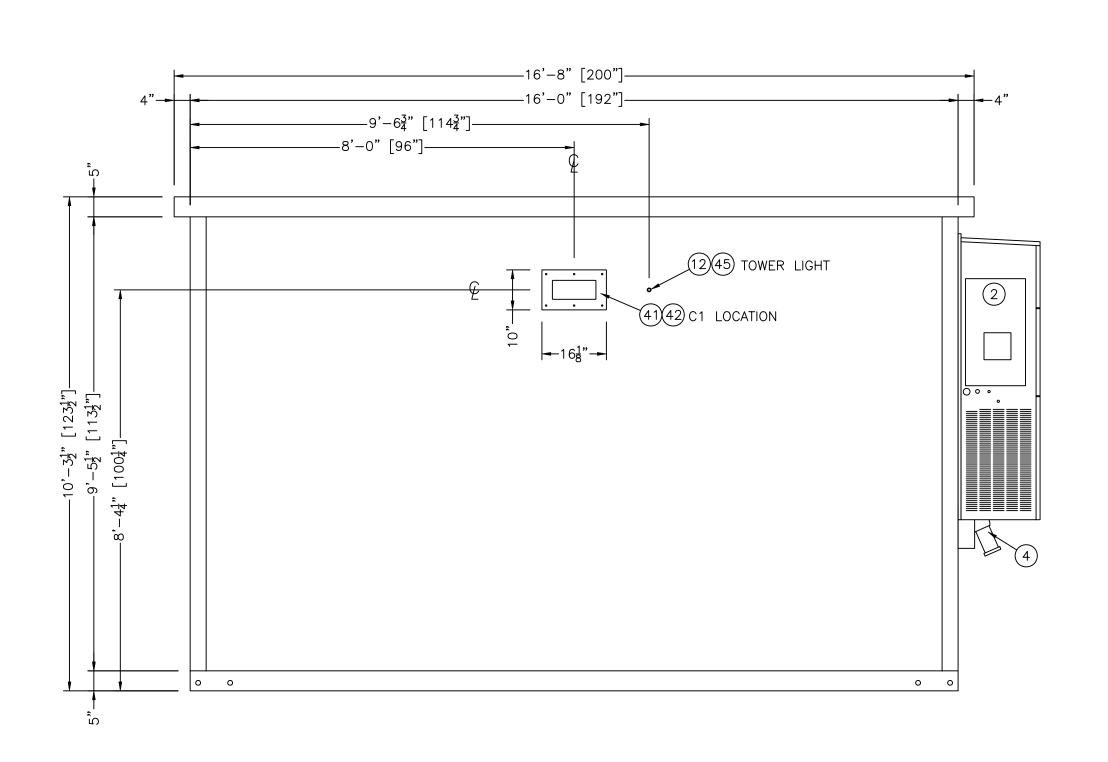
CUSTOMER:

TRITEL COMMUNICATIONS

PROJECT: 10'-0" X 16'-0" EQUIPMENT SHELTER EXTERIOR ELEVATIONS PANEL "A"

FILENAME: TTL20\TTL201-0	
SCALE: 1/2"=1'-0"	TOLERANCE:
DRWN. BY:	DATE:
V. HASSELL CHK. BY:	<i>11/10/99</i> DATE:
V. HASSELL ENG. BY:	<i>11/10/99</i> DATF:
K. BARNETT	11/10/99
APP. BY: M. MAYFIFI D	DATE:
SHEET NO.	11/10/99
1-0	
DRAWING NO.:	


DRAWING NO.:
STTL20 T



EXTERIOR ELEVATION "C"

1	MRC	6/14/00	ADDED PIPE CAP	VGH	6/14/00
Н	GE	4/10/00	ADDED: DIM. TO WAVEGUIDE; REMV'D. MICROFLECT WAVEGUIDE	GE	4/10/00
Ε	SM	3/1/00	REMOVED LOWER WAVEGUIDES	VGH	3/1/00
С	SM	2/1/00	ADDED DIMENSIONS FOR WAVEGUIDE BLOCKOUTS	VGH	2/1/00
В	VGH	1/4/00	CHANGES MADE PER CUSTOMER REVIEW OF PROTOTYPE	VGH	1/4/00
Α	SM	12/28/99	ADDED 1" PVC	VGH	12/28/99
REV	BY	DATE	DESCRIPTION	APP.BY	DATE

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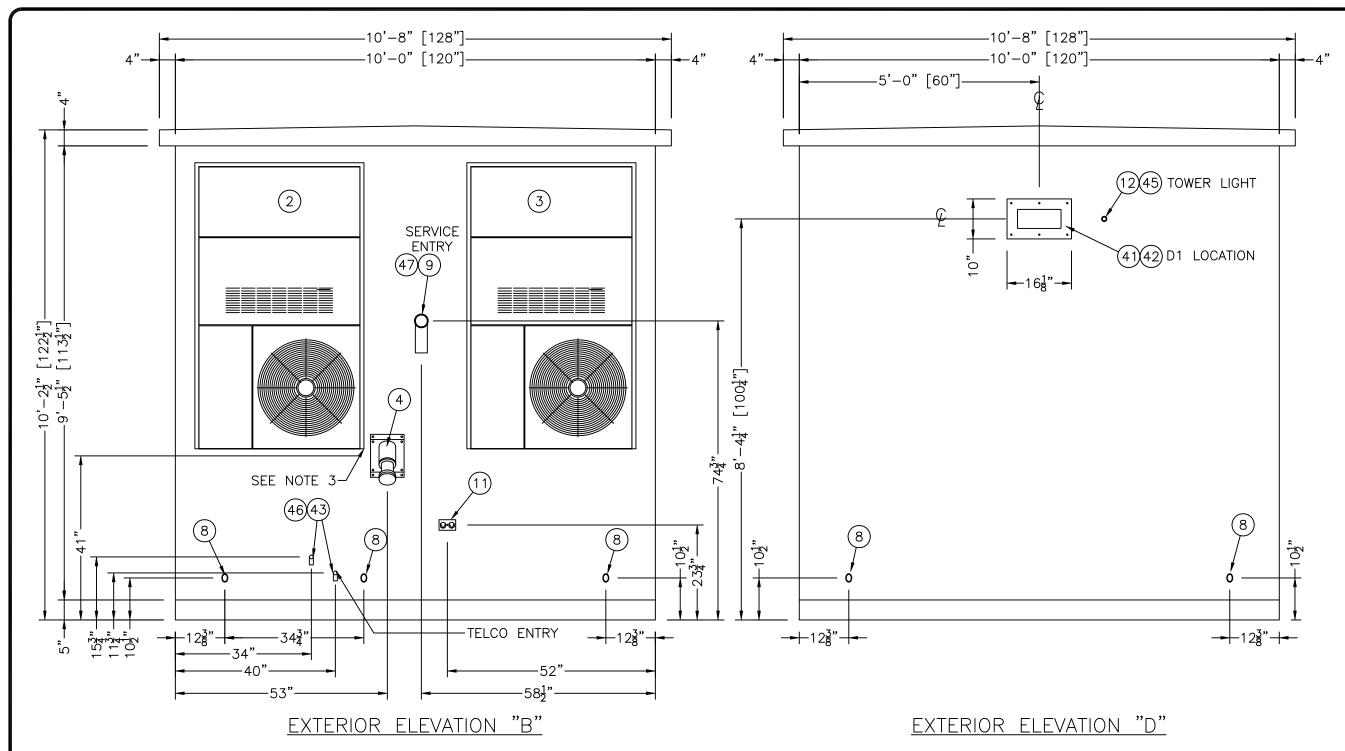


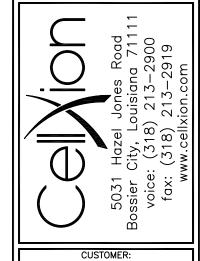TRITEL COMMUNICATIONS

PROJECT:
10'-0" X 16'-0"
EQUIPMENT SHELTER
EXTERIOR ELEVATIONS
PANEL "C"

FILENAME:	
TTL20\TTL201-1	
SCALE:	TOLERANCE:
1/2"=1'-0"	
DRWN. BY:	DATE:
V. HASSELL	11/10/99
CHK. BY:	DATE:
V. HASSELL	11/10/99
ENG. BY:	DATE:
K. BARNETT	11/10/99
APP. BY:	DATE:
M. MAYFIELD	11/10/99
SHEET NO.	
1 – 1	

DRAWING NO.:
STTL20



- 1. INSTALL WAVEGUIDE ENTRY FOR WAVEGUIDE CONFIGURATION D1. INSTALL BLANK PLATE FOR WAVEGUIDE CONFIGURATION C1.
- 2. WHEN STATIONARY EMERGENCY POWER SUPPLY IS UTILIZED, A/C INTERLOCK MUST BE CONNECTED TO HVAC UNIT #2 (ITEM 3) THROUGH EXTERIOR KNOCKOUT LOCATED ON LEFT SIDE OF UNIT. SEE SHEET 5-1 FOR WIRING DIAGRAM.
- 3. REROUTE AND EXTEND CONDENSATE DRAIN TO AVOID DRAINAGE ONTO ITEM #43.

L	CTF	10/18/00	MOVED HVAC CONDENSATE DRAIN	VGH	10/18/00
1	MRC	6/15/00	ADDED ITEMS 46 & 47	VGH	6/15/00
Н	GE	4/10/00	ADDED: DIM. TO WAVEGUIDE; REMV'D. MICROFLECT WAVEGUIDE	VGH	4/10/00
G	VGH	3/15/00	REVISED TELCO LOCATION	VGH	3/15/00
Ε	SM	3/1/00	REMOVED LOWER WAVEGUIDES	VGH	3/1/00
D	SM	2/8/00	REVERSED 1" CONDULETS TO MATCH INTERIORS	VGH	2/8/00
С	GE	1/27/00	RELOCATED SERVICE ENTRY & ADDED WAVEGUIDE DIMENSIONS	VGH	1/27/00
В	VGH	1/5/00	CHANGES MADE PER REVIEW OF PROTOTYPE BY CUSTOMER	VGH	1/5/00
Α	GE	12/28/99	MIRRORED ITEMS 4 AND 9	VGH	12/28/99
REV	BY	DATE	DESCRIPTION	APP.BY	DATE

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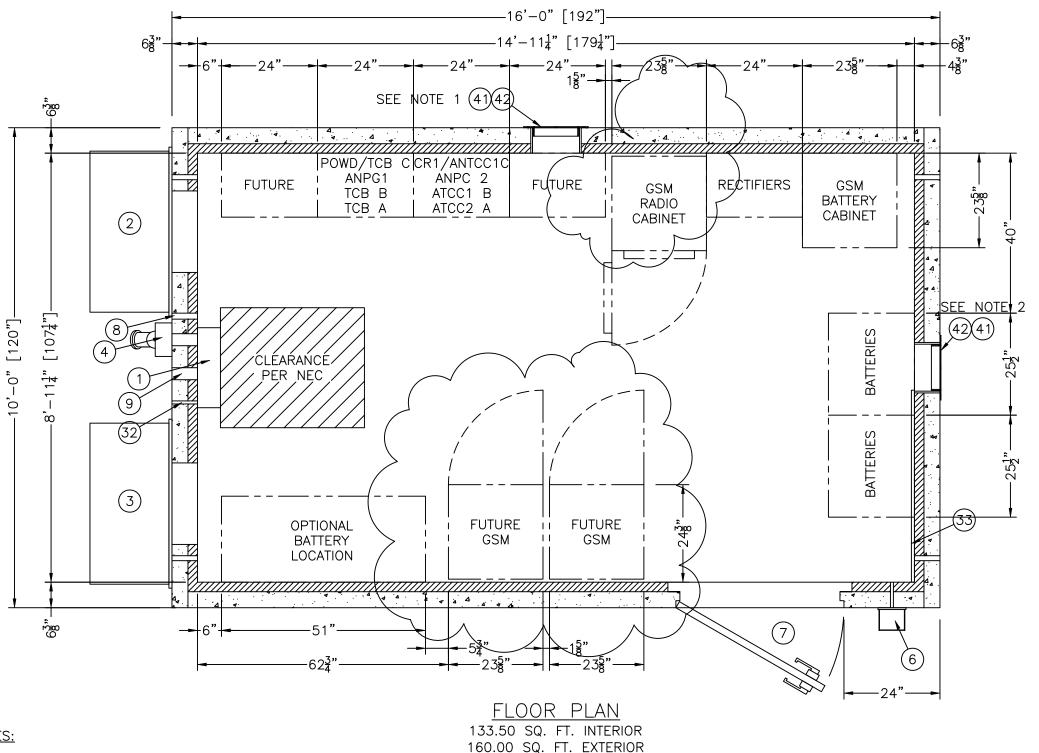


CUSTOMER:

TRITEL COMMUNICATIONS

PROJECT:
10'-0" X 16'-0"
EQUIPMENT SHELTER
EXTERIOR ELEVATIONS
PANELS "B & D"

FILENAME:	
TTL20\TTL201-2	
SCALE:	TOLERANCE:
1/2"=1'-0"	
DRWN. BY:	DATE:
V. HASSELL	11/10/99
CHK. BY:	DATE:
V. HASSELL	11/10/99
ENG. BY:	DATE:
K. BARNETT	11/10/99
APP. BY:	DATE:
M. MAYFIELD	11/10/99
SHEET NO.	
 1-2	
DRAWING NO.:	



1. INSTALL WAVEGUIDE ENTRY FOR ENTRY CONFIGURATION C1. INSTALL BLANK PLATE FOR ENTRY CONFIGURATION D1.

2. INSTALL WAVEGUIDE ENTRY FOR ENTRY CONFIGURATION D1. INSTALL BLANK PLATE FOR ENTRY CONFIGURATION C1.

	Т	WAR	05/14/02	ADDED 2 FUTURE GSM, RADIO & BATTERY CABINET	VGH	05/14/02
	Я	MRC	4/19/02	CHANGED ONE FUTURE RECTIFIER TO GSM	VGH	4/19/02
Ī	R	MRC	8/28/01	REVISED PRINT: MADE NEC CLEARANCE TO 30" X 36"	VGH	8/28/01
Ī	L	CTF	10/18/00	ADDED CONDENSATE PENETRATION	VGH	10/18/00
Ī	H	GE	4/10/00	REMOVED MICROFLECT WAVEGUIDE ITEMS 5 AND 30	VGH	4/10/00
Ī	Ε	SM	3/1/00	MODIFIED EQUIPMENT LAYOUT	VGH	3/1/00
Ī	В	SM	1/05/00	MODIFIED BATTERY AND DSX PLACEMENT	VGH	1/05/00
Ī	REV	BY	DATE	DESCRIPTION	APP.BY	DATE

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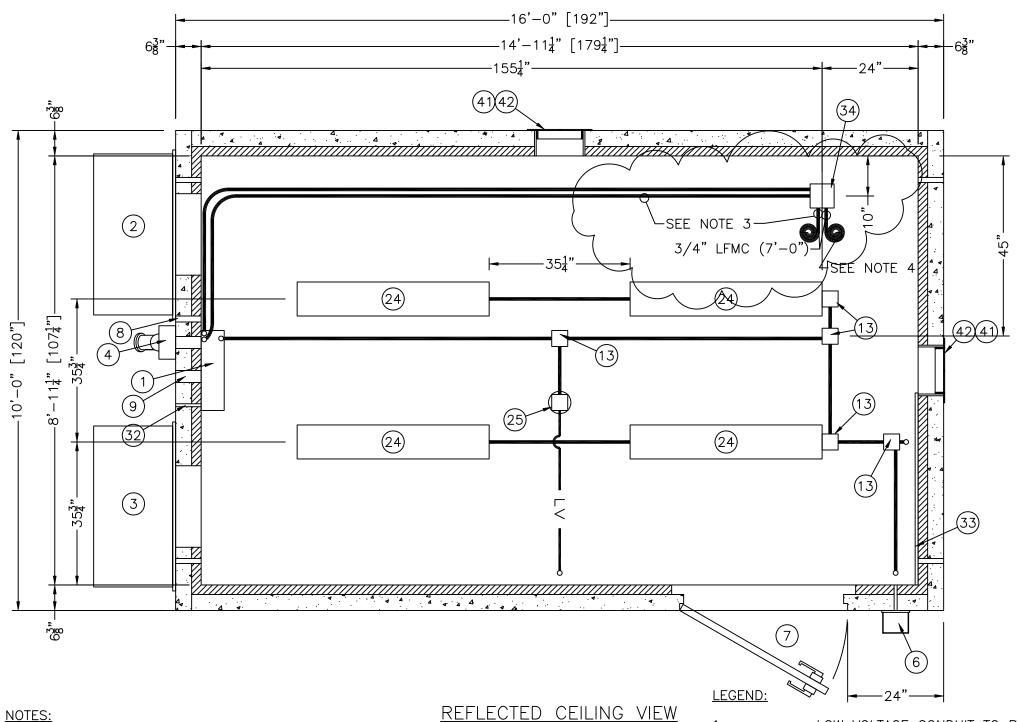


CUSTOMER:

TRITEL COMMUNICATIONS

PROJECT: 10'-0" X 16'-0" EQUIPMENT SHELTER FLOOR PLAN

	FILENAME:	
ı	TTL20\TTL202-0	
ı	SCALE:	TOLERANCE:
ı	1/2"=1'-0"	
	DRWN. BY:	DATE:
	V. HASSELL	11/10/99
ı	CHK. BY:	DATE:
ı	V. HASSELL	11/10/99
ı	ENG. BY:	DATE:
ı	K. BARNETT	11/10/99
ı	APP. BY:	DATE:
ı	M. MAYFIELD	11/10/99
ı	SHEET NO.	
ı	2-0	
ı		
ı	DRAWING NO.:	



ELECTRICAL

1. ALL CONDUIT TO BE 3/4" EMT, UNLESS OTHERWISE NOTED.

2. PLACEMENT OF ELECTRICAL EQUIPMENT TO DETERMINED BY AVAILABILITY OF PREMADE KNOCK-OUTS OR PENETRATION REQUIREMENTS.

- 3. CIRCUITS 20 & 22 ONLY.
- 4. RECTIFIER CIRCUITS MUST BE TAGGED FOR IDENTIFICATION.

1.——— = LOW VOLTAGE CONDUIT TO BE 1/2" EMT UNLESS OTHERWISE NOTED.

--- = HALO GROUND WIRE TO BE #6 STRANDED GREEN COPPER WIRE AND DROPS TO BE #2 BARE SOLID TINNED COPPER WIRE.

S	MRC	4/19/02	REVISED PRINT: CHANDED NOTE NUMBER 3	VGH	4/19/02
Ν	MRC	11/28/00	REVISED PRINT: MADE TYPO CORRECTION	VGH	11/28/00
М	CTF	11/07/00	UPDATED CONDUIT RUNS	VGH	11/07/00
L	CTF	10/18/00	UPDATED PER NEW DWG. STANDARDS	VGH	10/18/00
Ε	SM	3/4/00	MOVED ITEM 34 24"	VGH	3/4/00
С	SM	2/1/00	ADDED NOTE 4; MOVED CENTER CONDUIT RUN	VGH	2/1/00
В	SM	1/06/00	REROUTED CONDUIT	VGH	1/06/00
REV	BY	DATE	DESCRIPTION	APP.BY	DATE

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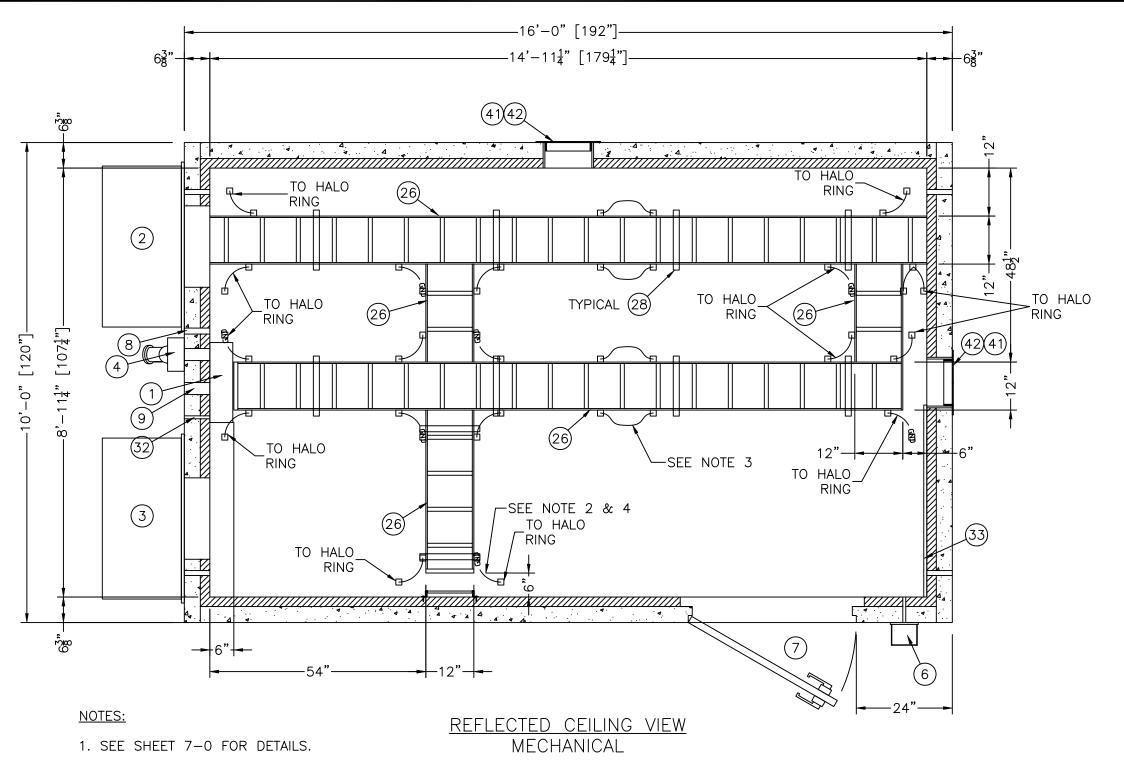


CUSTOMER:

TRITEL COMMUNICATIONS

PROJECT: 10'-0" X 16'-0" EQUIPMENT SHELTER REFLECTED CEILING VIEW ELECTRICAL

FILENAME: TTL20\TTL203-0	
SCALE: 1/2"=1'-0"	TOLERANCE:
DRWN. BY: V. HASSELL	DATE: 11/10/99
CHK. BY: V. HASSELL	DATE: 11/10/99
ENG. BY: K. BARNETT	DATE: 11/10/99
APP. BY: M. MAYFIELD	DATE: 11/10/99
SHEET NO. 3-0	
DRAWING NO.:	




2. CABLE LADDER TO BE CONNECTED TO HALO AT ALL POINTS, USING #2 GREEN INSULATED, TWO HOLE LONG BARRELL LUGS, ON LADDER AND CRIMP LUGS FOR CONNECTION TO HALO.

- 3. JUMPERS TO BE INSTALLED AT ALL SPLICE CONNECTIONS USING #6 GREEN INSULATED CONDUCTOR W/ TWO HOLE LONG BARRELL LUGS.
- 4. ALL JUMPER AND HALO CONNECTIONS SHALL BE OMNI-DIRECTIONAL.

R	MRC	8/28/01	REVISED PRINT: REMOVED HALO RING FROM THIS VIEW	VGH	8/28/01	
0	CTF	12/7/00	REVISED PRINT: ERASED LAYERS	VGH	12/7/00	
L	CTF	10/18/00	ADDED GROUNDING TO CABLE TRAY	VGH	10/18/00	
Н	GE	4/10/00	ADDED: WALL MOUNTED CABLE TRAY, ITEM #26	VGH	4/10/00	
С	SM	2/1/00	MOVED CABLE TRAY 6" OFF WALL AT PANELBOARD	MM	1/24/00	
REV	BY	DATE	DESCRIPTION	APP.BY	DATE	


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TRITEL COMMUNICATIONS

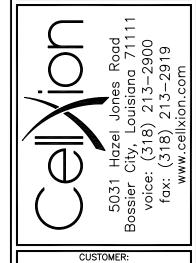PROJECT: 10'-0" X 16'-0" EQUIPMENT SHELTER REFLECTED CEILING VIEW MECHANICAL

l	
FILENAME:	
TTL20\TTL203-1	
SCALE:	TOLERANCE:
1/2"=1'-0"	
DRWN. BY:	DATE:
V. HASSELL	11/10/99
CHK. BY:	DATE:
V. HASSELL	11/10/99
ENG. BY:	DATE:
K. BARNETT	11/10/99
APP. BY:	DATE:
M. MAYFIELD	11/10/99
SHEET NO.	
.3-1	
DRAWING NO.:	



- 1. ALL CONDUIT TO BE 3/4" EMT, UNLESS OTHERWISE NOTED.
- 2. PLACEMENT OF ELECTRICAL EQUIPMENT TO DETERMINED BY AVAILABILITY OF PREMADE KNOCK-OUTS OR PENETRATION REQUIREMENTS.

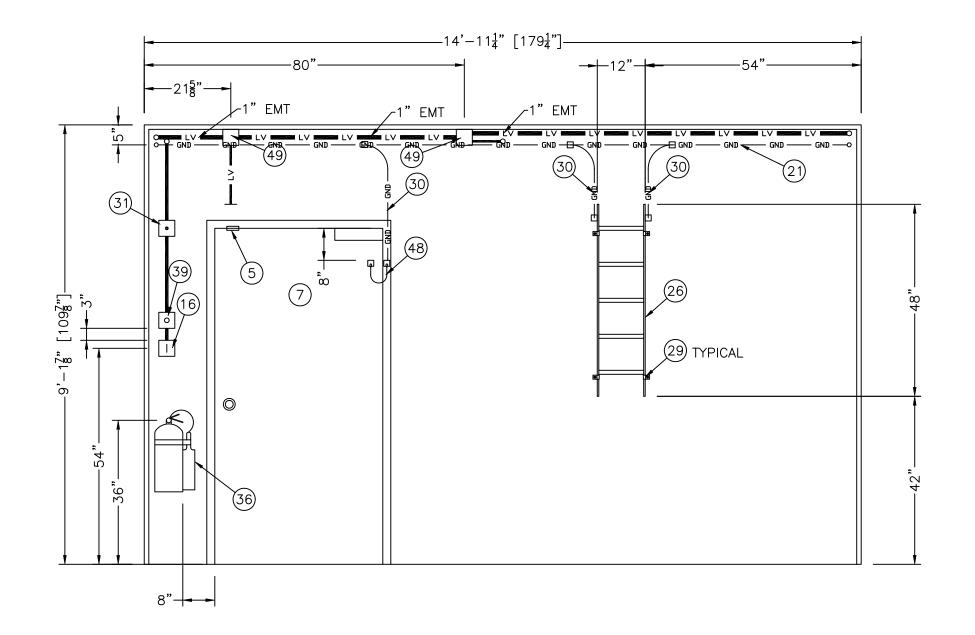INTERIOR ELEVATION "A"

LEGEND:

1.— LV — = LOW VOLTAGE CONDUIT TO BE 1/2" EMT UNLESS OTHERWISE NOTED.

2.— GND— = HALO GROUND RING AND DROPS TO BE #2 STRANDED GREEN COPPER WIRE AND COILS TO BE #2 BARE SOLID TINNED COPPER WIRE.

R	MRC	8/28/01	ADDED ITEM BUBBLES 5,21,36 AND CHG'D TEXT TO LEGEND	VGH	8/28/01
L	CTF	10/08/00	UPDATED PER MNEW DWG. STANDARDS	VGH	10/18/00
H	GE	4/10/00	ADDED: WALL MOUNTED CABLE TRAY, ITEM #26	VGH	4/10/00
В	SM	1/06/00	REVISED PRINTS PER CUSTOMER REVIEW OF PROTOTYPE	VGH	1/06/00
Α	SM	12/28/99	ADDED FIRE EXTING. / REMOVED CON. BELOW LIGHT SWITCH	VGH	12/28/99
REV	BY	DATE	DESCRIPTION	APP.BY	DATE

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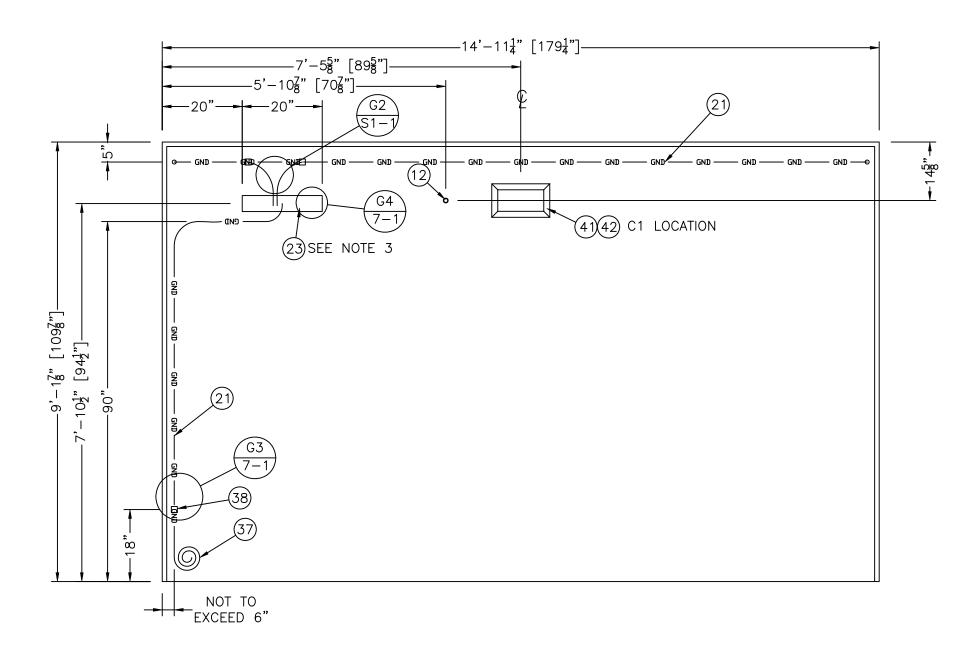
CUSTOMER:

TRITEL

COMMUNICATIONS

PROJECT: 10'-0" X 16'-0" EQUIPMENT SHELTER INTERIOR ELEVATIONS PANEL "A"

FILENAME	:		
TTL20\T	TL204-0		
SCALE:		TOLERAN	CE:
1/2"=	1'-0"		
DRWN. B	Y:	DATE:	
V. HA	SSELL	11/1	0/99
CHK. BY	:	DATE:	
V. HA	SSELL	11/1	0/99
ENG. BY:		DATE:	
K. BA	RNETT	11/1	0/99
APP. BY:		DATE:	
M. MA	YFIELD	11/1	0/99
SHEET N	0.		
 4 -	-0		
1			
DRAWING	NO.:		
 STT1 2	0		T



- 1. ALL CONDUIT TO BE 3/4" EMT, UNLESS OTHERWISE NOTED.
- 2. PLACEMENT OF ELECTRICAL EQUIPMENT TO DETERMINED BY AVAILABILITY OF PREMADE KNOCK-OUTS OR PENETRATION REQUIREMENTS.
- 3. USE 2 HOLE LONG BARREL LUGS TO CONNECT GROUND WIRE TO GROUND BAR. ANTI-OXIDATION COMPOUND MUST BE USED AT CONNECTION.
- 4. LUG LOCATION CLOSEST TO THE CENTER ON THE LEFT SIDE OF GROUND BAR AS POSSIBLE.

INTERIOR ELEVATION "C"

LEGEND:

1.— LV — = LOW VOLTAGE CONDUIT TO BE 1/2" EMT UNLESS OTHERWISE NOTED.

2.— GND— = HALO GROUND AND GROUND DROPS TO BE #2 STRANDED GREEN COPPER WIRE, COILS TO BE #2 SOLID TINNED COPPER WIRE.

F	MR	8/24/01	REVISED PRINT: ADDED GROUNDING DETAIL BUBBLES	VGH	8/24/01	
L	. CTF	10/18/00	CHGD. GROUNDING ROUTES	VGH	10/18/00	
H	I GE	4/10/00	REMOVED ITEMS 5 AND 30, MICROFLECT WAVEGUIDE	VGH	4/10/00	
E	SM	3/1/00	REMOVED LOWER WAVEGUIDES	VGH	3/1/00	
	SM	2/2/00	REMOVED 1 RUN CONDUIT, MADE REMAINING CONDUIT LV	VGH	2/2/00	
RE	V BY	DATE	DESCRIPTION	DESCRIPTION APP.BY DATE		

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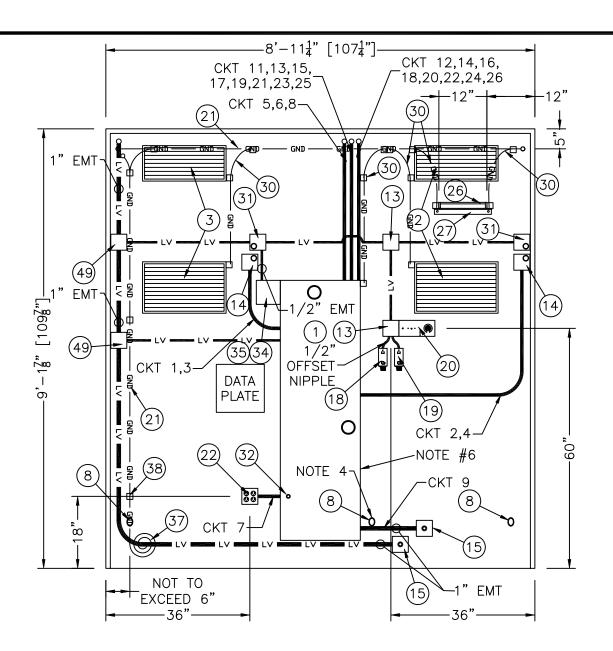
CUSTOMER:


TRITEL

COMMUNICATIONS

PROJECT: 10'-0" X 16'-0" EQUIPMENT SHELTER INTERIOR ELEVATIONS PANEL "C"

- 1	-		
ı	FILENAME:		
١	TTL20\TTL204-1		
١	SCALE:	TOLERAN	ICE:
١	1/2"=1'-0"		
ı	DRWN. BY:	DATE:	
١	V. HASSELL	11/1	0/99
١	CHK. BY:	DATE:	
ı	V. HASSELL	11/1	0/99
١	ENG. BY:	DATE:	
ı	K. BARNETT		0/99
١	APP. BY:	DATE:	
١	M. MAYFIELD	11/1	0/99
١	SHEET NO.		
١	4-1		
ı			
ı	DRAWING NO.:		
١	STTI 20		T



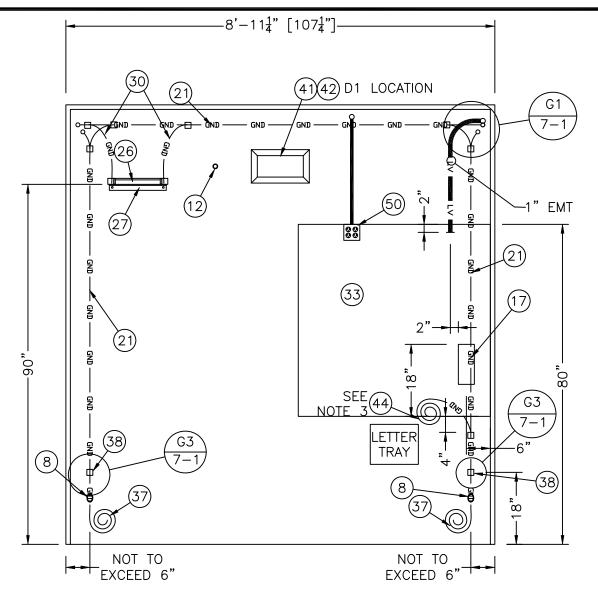

INTERIOR ELEVATION "B"

- 1. ALL CONDUIT TO BE 3/4" EMT, UNLESS OTHERWISE NOTED.
- 2. PLACEMENT OF ELECTRICAL EQUIPMENT TO DETERMINED BY AVAILABILITY OF PREMADE KNOCK-OUTS OR PENETRATION REQUIREMENTS.
- 3. MAKE ITEM #44 COIL 6 FT.
- 4. PDC GROUND BUSS PENETRATION FOR CONNECTION TO EGR BY GENERAL CONTRACTOR.
- 5. GROUNDING CONDUCTOR TAPS TO BE ROUTED TO DIRECT WIRE TOWARDS NEAREST HALO EXIT PENETRATION.
- 6. IN CENTER OF SIDE PANEL ON OPPOSITE SIDE OF QUAD RECEPTACLE, DRILL 3/8"\"\phi\ HOLE, 11" UP FROM BOTTOM OF PANEL, FOR EGR GROUND WIRE.

INTERIOR ELEVATION "D"

LEGEND:

1.— LV — = LOW VOLTAGE CONDUIT TO BE 1/2" EMT UNLESS OTHERWISE NOTED.

2.— GND— = HALO GROUND AND GROUND DROPS TO BE #2 STRANDED GREEN COPPER WIRE, COILS TO BE #2 SOLID TINNED COPPER WIRE.

R	MRC	8/28/01	ADDED CKT CALLOUTS AND NOTE NUMBER 6	VGH	8/28/01
М	CTF	11/07/00	CHGD CONDUIT RUNS	VGH	11/07/00
L	CTF	10/18/00	UPDATED PER NEW DWG. STANDARDS	VGH	10/18/00
Н	GE	4/10/00	REMOVED ITEMS 5 AND 30, MICROFLECT WAVEGUIDE	VG VG	4/10/00
Ε	SM	3/1/00	REMOVED LOWER WAVEGUIDES	VG VG	3/1/00
D	SM	2/8/00	REVERSED HVAC UNITS TO MATCH EXTERIOR VIEWS	VG VG	2/8/00
С	GE	1/27/00	MOVED SERVICE ENTRY, REMOVED ITEM 27, MODIFIED LV CON	J. VGH	1/27/00
В	SM	1/06/00	CHANGES MADE PER REVIEW OF PROTOTYPE BY CUSTOMER	VG VG	1/06/00
Α	SM	12/28/99	MOVED PWR FAIL/ REVERSED GEN. RECEPT. & SERVICE ENT.	VGH	12/28/99
REV	BY	DATE	DESCRIPTION	APP.BY	DATE

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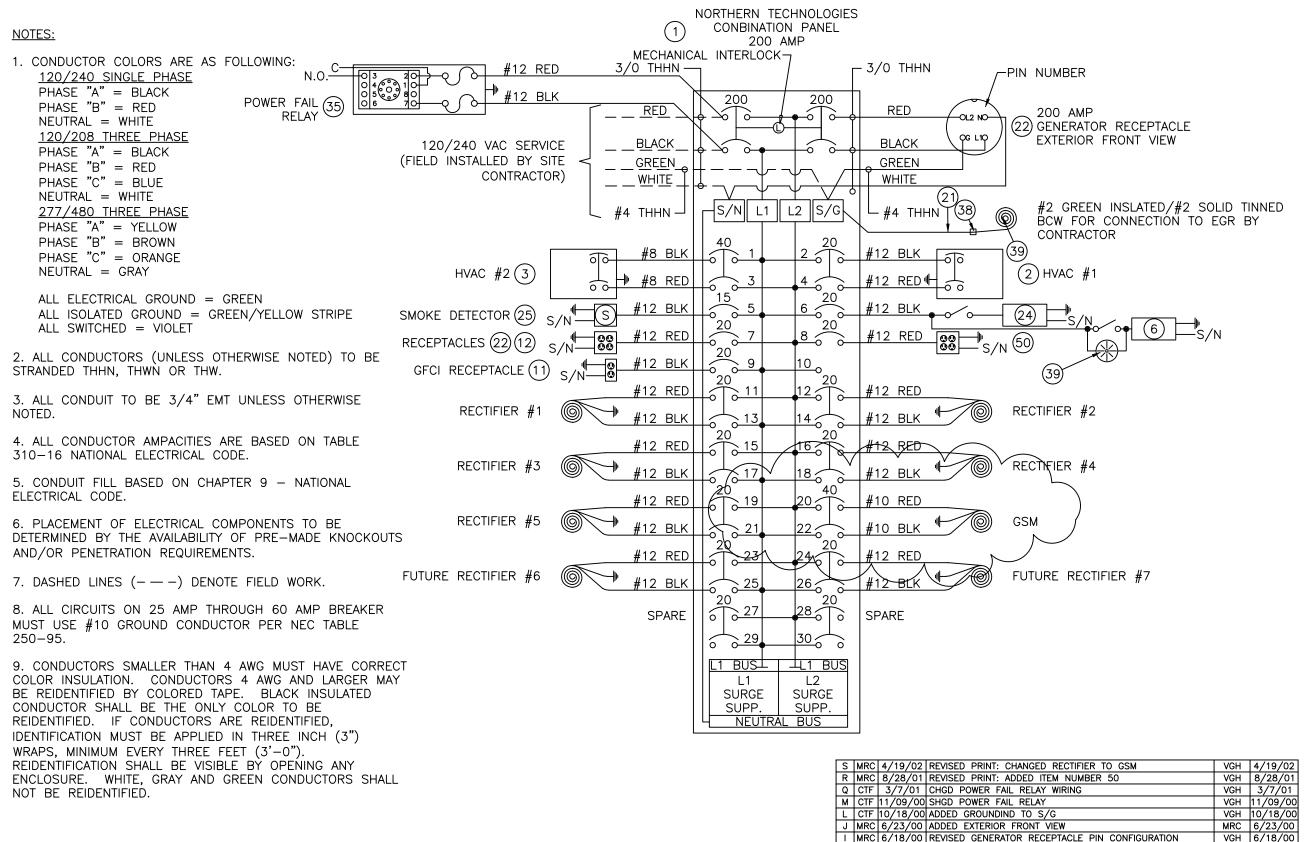
CUSTOMER:

TRITEL

COMMUNICATIONS

PROJECT:
10'-0" X 16'-0"
EQUIPMENT SHELTER
INTERIOR ELEVATIONS
PANELS "B & D"

FILENAME: TTL20\TTL204-2	
SCALE:	TOLERANCE:
1/2"=1'-0"	
DRWN. BY:	DATE:
V. HASSELL	11/10/99
CHK. BY:	DATE:
V. HASSELL	11/10/99
ENG. BY:	DATE:
K. BARNETT	11/10/99
APP. BY:	DATE:
M. MAYFIELD	11/10/99
SHEET NO.	
4-2	
DRAWING NO.:	



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CUSTOMER:

TRITEL COMMUNICATIONS

PROJECT: 10'-0" X 16'-0" EQUIPMENT SHELTER ELECTRICAL SCHEMATIC

FILENAME:				
TTL20\TTL205-0	TTL20\TTL205-0			
SCALE:	TOLERAN	ICE:		
N.T.S.				
DRWN. BY:	DATE:			
S. MARTIN	11/1	2/99		
CHK. BY:	DATE:			
V. HASSELL	11/1	2/99		
ENG. BY:	DATE:			
K. BARNETT	11/1	2/99		
APP. BY:	DATE:			
M. MAYFIELD	11/1	2/99		
SHEET NO.				
5-0				
DRAWING NO.:				
STTL20		T		

VGH 3/1/00

VGH 2/8/00

VGH 2/2/00 APP.BY DATE


E SM 3/1/00 ADDED FUTURE RECTIFIERS, MODIFIED ITEM #2 WIRE SIZE


A SM 2/2/00 REMOVED NOTE 8; ROTATED GEN. RECPT.; ADDED CIRCUIT 8;

MODIFIED SURGE SUPPRESSOR; REMOVED SERVICE BOND


DESCRIPTION

D SM 2/8/00 REVERSED HVAC UNITS TO MATCH EXTERIOR VIEWS

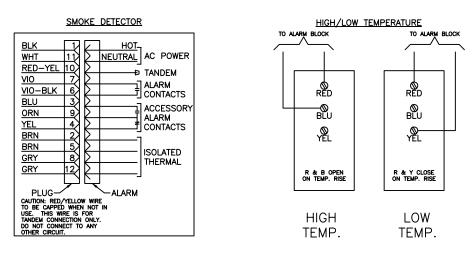

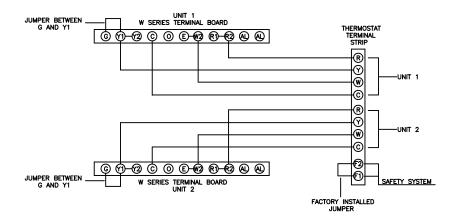


<u>EUBANKS</u> <u>LEAD/LAG CONTROLLER - LLC</u>

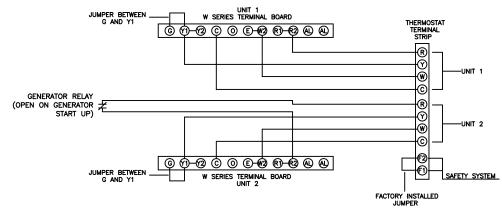

STATIONARY EMERGENCY POWER

A/C INTERLOCK

(FIELD INSTALLED)

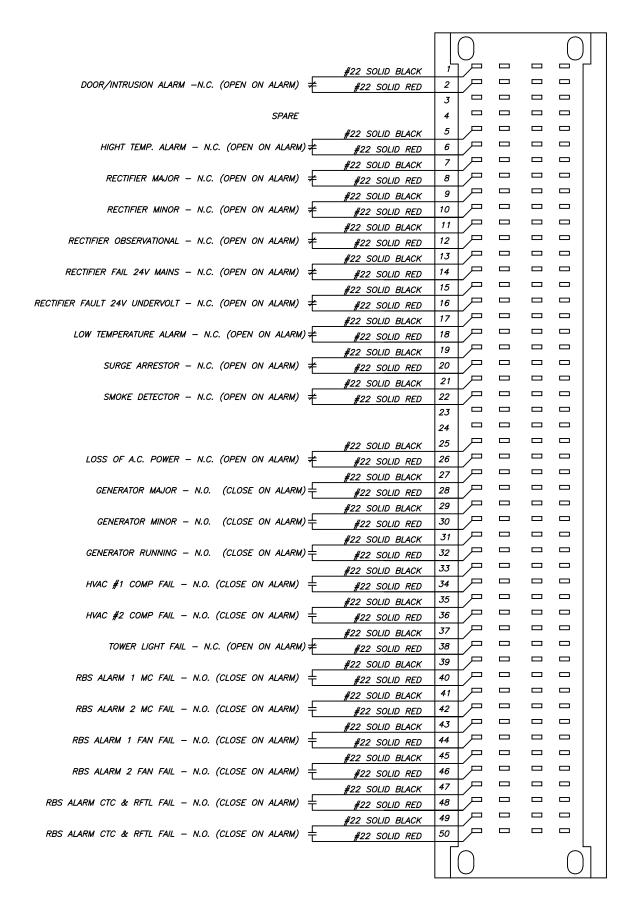

1	MRC	6/14/00	CHANGED NO TO NC VISA VERSA	VGH	6/14/00
С	SM	2/1/00	CHANGED HVAC ALARMS & MODIFIED ALL OTHER SWITCHES	VGH	2/1/00
REV	BY	DATE	DESCRIPTION APP.BY DATE		

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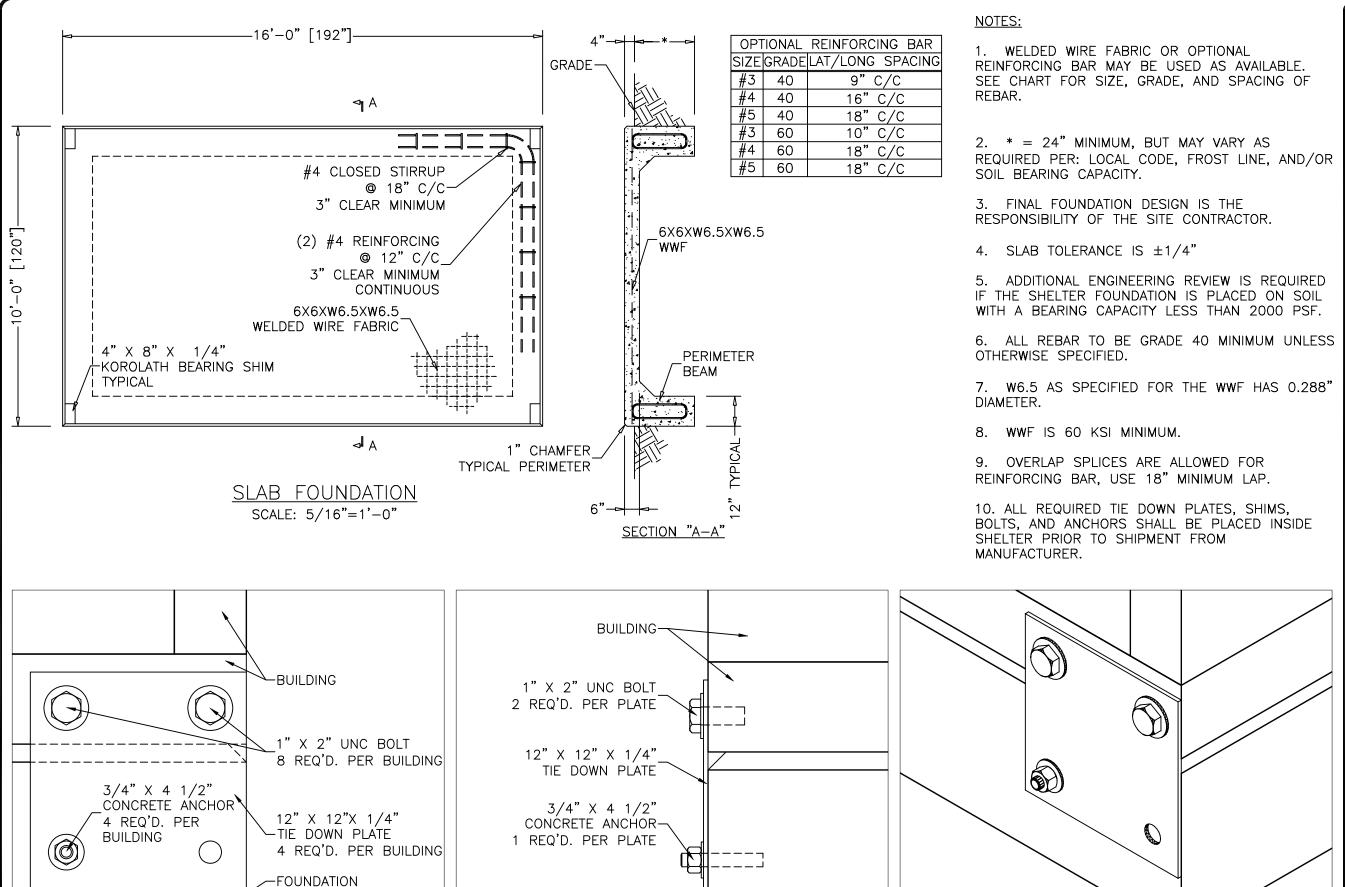


CUSTOMER:

TRITEL COMMUNICATIONS

PROJECT: 10'-0" X 16'-0" EQUIPMENT SHELTER LOW VOLTAGE WIRING

FILENAME: TTL20\TTL205-1	
SCALE:	TOLERANCE:
DRWN. BY:	DATE: 11/12/99
CHK. BY: V. HASSELL	DATE: 11/12/99
ENG. BY: K. BARNETT	DATE: 11/12/99
APP. BY: M. MAYFIELD	DATE: 11/12/99
SHEET NO. 5-1	,
DRAWING NO.:	



CONNECTION DETAIL SIDE

SCALE: 3/16"=1"

CONNECTION DETAIL FRONT

SCALE: 3/16"=1"

ENGINEER SEAL

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CUSTOMER:

TRITEL COMMUNICATIONS

PROJECT:
10'-0" X 16'-0"
EQUIPMENT SHELTER
FOUNDATION PLAN

FILENAME: TTL20\TTL206-0		
SCALE: NOTED	TOLERAN	CE:
DRWN. BY: V. HASSELL	DATE: 11/1	2/99
CHK. BY: V. HASSELL	DATE:	2/99
ENG. BY: K. BARNETT	DATE:	2/99
APP. BY: M. MAYFIELD	DATE:	2/99
SHEET NO.: 6-0	PART NO	
DRAWING NO.: STTL20		REV:


CONNECTION DETAIL ISOMETRIC


SCALE: 3/16"=1"

NOTES: 1. ADDITIONAL ENGINEERING REVIEW IS REQUIRED IF SHELTER FOUNDATION IS PLACED ON SOIL WITH A BEARING CAPACITY LESS THAN 2000 PSF AT BOTTOM OF PIER. 2. TOP OF PIERS MUST BE LEVEL ±1/4" 3. ALL REINFORCING BAR MUST BE GRADE 60 PER ASST. A615. 4. ALL REQUIRED TIE DOWN ANGLES, SHIMS, BOLTS AND ANCHORS SHALL BE PLACED INSIDE SHELTER PRIOR TO -SHELTER SHIPMENT FROM MANUFACTURER. ANGLE TIE DOWN BRACKET 5. ALL VERTICAL REINFORCING BAR IS P/N 220210-EQUALLY SPACED AROUND PERIMETER OF 4 REQ'D. (MIN.) PIER 3" CLEAR. 6. Fc' = 3000 PSI @ 28 DAYS 7. SOIL COHESION IS ASSUMED AT 50 PSF PER FT. OF DEPTH (NOT TO EXCEED 250 [36"] 8. SOIL DENSITY IS 100 PCF OR GREATER. **.** 9. SHELTER WIND LOAD IS 70 MPH PER 99 BOCA -GRADE 10. SIESMIC IS Av=.05 AND Aa=.05 [138"] **.**0 #3 REINFORCING TIES [102"] -8" C/C TOP 2'-0", 16" C/C BELOW 2'-0" (4) #8 VERTICAL œ RÉINFORCING BAR **├-**─24"—— ELEVATION VIEW

SCALE: 3/8"=1'-0"

TRITEL PROJECT NO. 315-004-R2A VANGUARD TOWERS-SOUTH NATCHEZ

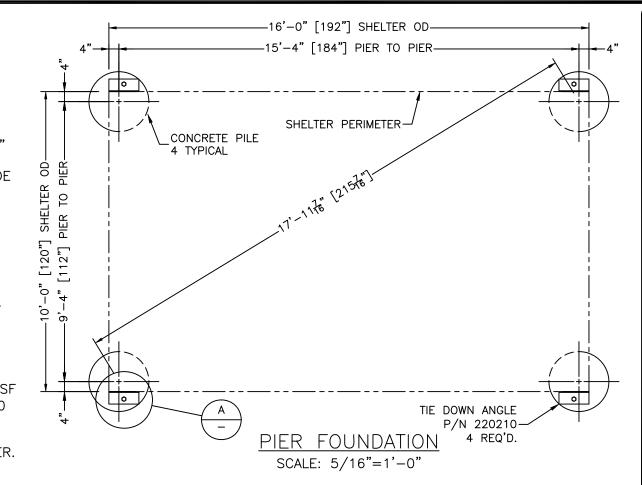

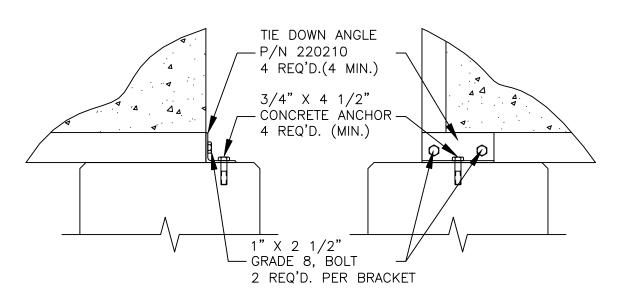

<u>DETAIL</u> "A"

SCALE: 3/4"=1'-0"

ENGINEER SEAL

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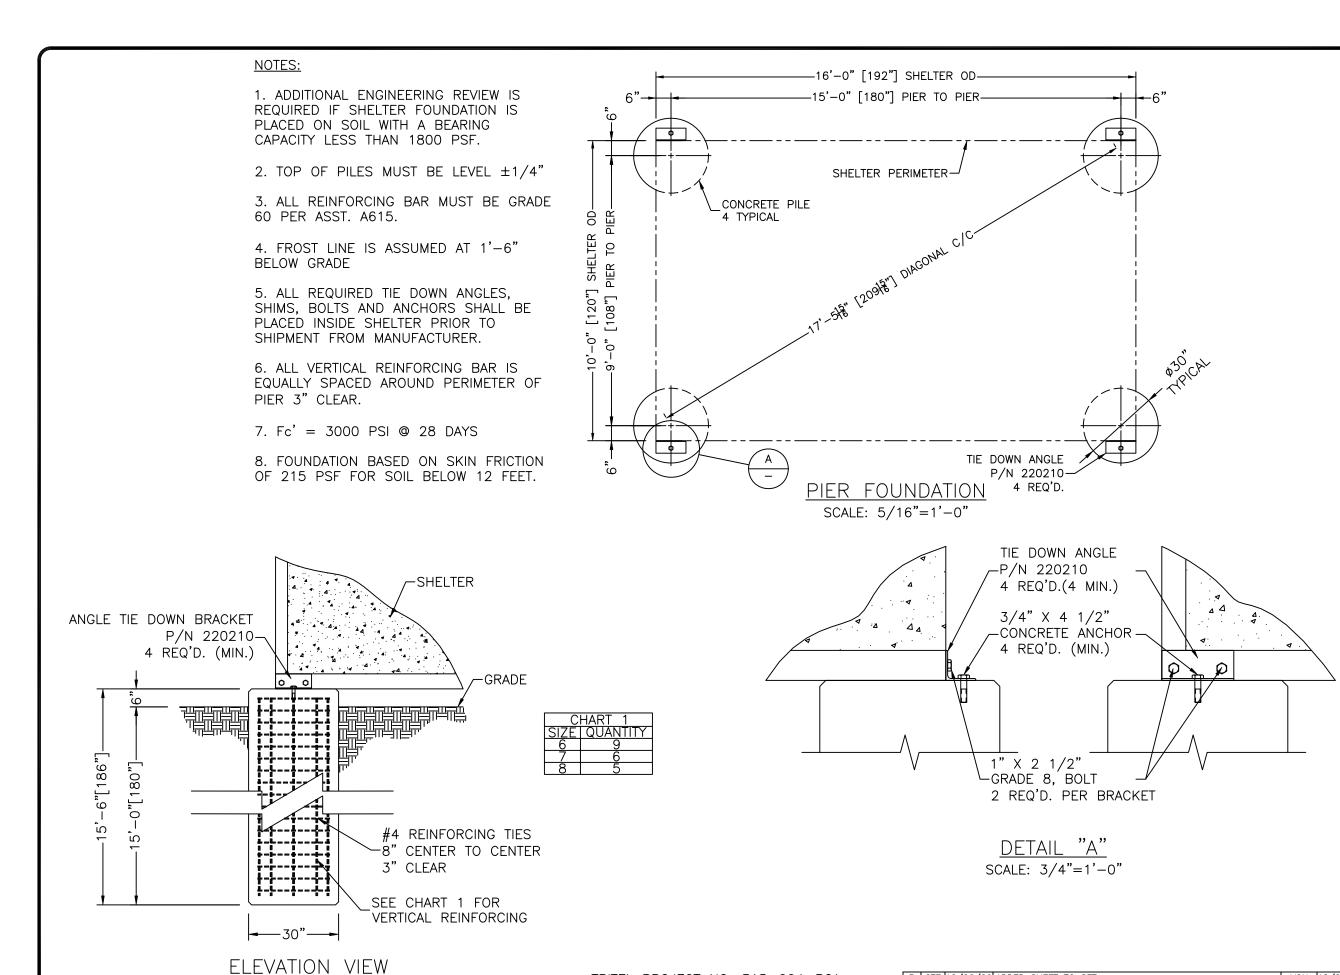


CUSTOMER:

TRITEL

PROJECT: 10'–0" X 16'–0" CONCRETE SHELTER 11'–6" PIER FOUNDATION PLAN

- 1			
ı	FILENAME:		
	ΠL20/SΠL206–1		
ı	SCALE:	TOLERAN	ICE:
	NOTED	NO	TED
	DRWN. BY:	DATE:	
	S. MARTIN	12/	4/00
ı	CHK. BY:	DATE:	
ı	V. HASSELL	12/	4/00
ı	ENG. BY:	DATE:	
ı	K. BARNETT	12/	4/00
ı	APP. BY:	DATE:	
ı	M. MAYFIELD	12/4	4/00
ı	SHEET NO.:	PART NO).:
ı	6-1		
ı			
ı	DRAWING NO.:		REV:
	STTI 20		T



TRITEL PROJECT NO. 315-004-R2A

VANGUARD TOWERS-SOUTH NATCHEZ

SCALE: 3/8"=1'-0"

P CTF 12/26/00 ADDED SHEET TO SET REV BY DATE

DESCRIPTION

THIS DRAWING IS THE CONFIDENTIAL PROPERTY AND CONTAINS TRADE

ENGINEER SEAL

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CUSTOMER:

TRITEL

PROJECT: 10'-0" X 16'-0" CONCRETE, SHELTER 15'-6" PIER FOUNDATION PLAN

FILENAME:		
20415	T TOLEDAN	105
SCALE:	TOLERAN	
NOTED	NO	TED
DRWN. BY:	DATE:	
C. FOSTER	12/2	6/00
CHK. BY:	DATE:	
V. HASSELL	12/2	6/00
ENG. BY:	DATE:	
K. BARNETT	12/2	6/00
APP. BY:	DATE:	
M. MAYFIELD	12/2	6/00
SHEET NO.:	PART NO).:
6-2		
DRAWING NO.:		REV:
STTI 20		l T


VGH 12/26/00 APP.BY DATE


1. ADDITIONAL ENGINEERING REVIEW IS REQUIRED IF SHELTER FOUNDATION IS PLACED ON SOIL WITH A BEARING CAPACITY LESS THAN 2500 PSF AT BOTTOM OF PIER. 2. TOP OF PIERS MUST BE LEVEL ±1/4" 3. ALL REINFORCING BAR MUST BE GRADE 60 PER ASST. A615. 4. ALL REQUIRED TIE DOWN ANGLES, SHIMS, BOLTS AND ANCHORS SHALL BE PLACED INSIDE SHELTER PRIOR TO -SHELTER SHIPMENT FROM MANUFACTURER. ANGLE TIE DOWN BRACKET 5. ALL VERTICAL REINFORCING BAR IS P/N 220210-EQUALLY SPACED AROUND PERIMETER OF 4 REQ'D. (MIN.) PIER 3" CLEAR. 6. Fc' = 3000 PSI @ 28 DAYS 7. SOIL COHESION IS ASSUMED AT 50 PSF PER FT. OF DEPTH (NOT TO EXCEED 250 8. SOIL DENSITY IS 60 PCF OR GREATER. **.**9 9. SHELTER WIND LOAD IS 100 MPH PER g 97 SBC. -GRADE 10. SIESMIC IS Av=.05 AND Aa=.05 [270"] 11. GROUND WATER IS AT 12 FEET. DEWATERING MAY BE REQUIRED. ... 22, #3 REINFORCING TIES [156"]--8" C/C TOP 6'-0", 16" C/C BELOW 6'-0" ,0 (4) #8 VERTICAL 'n RÉINFORCING BAR ---24"---ELEVATION VIEW SCALE: 3/8"=1'-0"

TRITEL PROJECT NO. 210-105-00A

BAY POINT, RANKIN COUNTY, MS.

NOTES:

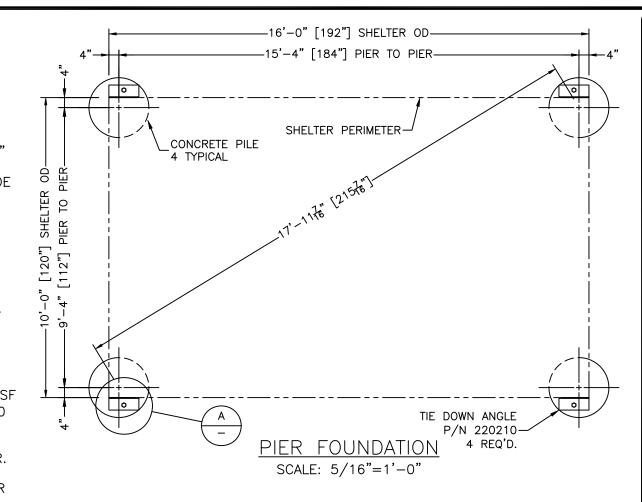

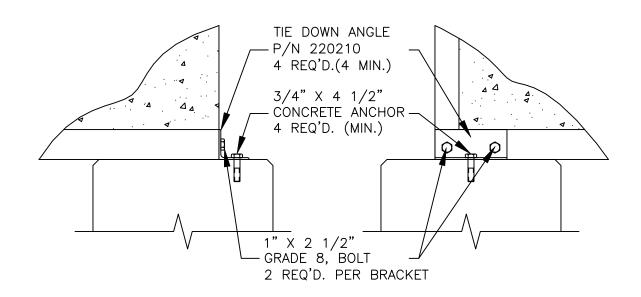

<u>DETAIL</u> "A"

SCALE: 3/4"=1'-0"

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ENGINEER SEAL




CUSTOMER:

TRITEL

PROJECT: 10'-0" X 16'-0" CONCRETE, SHELTER 22'-6" PIER FOUNDATION PLAN

	FILENAME:		
ı	SCALE:	TOLERAN	ICE:
ı	NOTED	NO	TED
ı	DRWN. BY:	DATE:	
ı	C. FOSTER	9/1	8/01
	CHK. BY:	DATE:	
	V. HASSELL	9/1	8/01
	ENG. BY:	DATE:	
	K. BARNETT	9/1	8/01
	APP. BY:	DATE:	
	M. MAYFIELD	9/1	8/01
	SHEET NO.:	PART NO).:
	6-3		
	DRAWING NO.:	l.	REV:
	STTL20		T

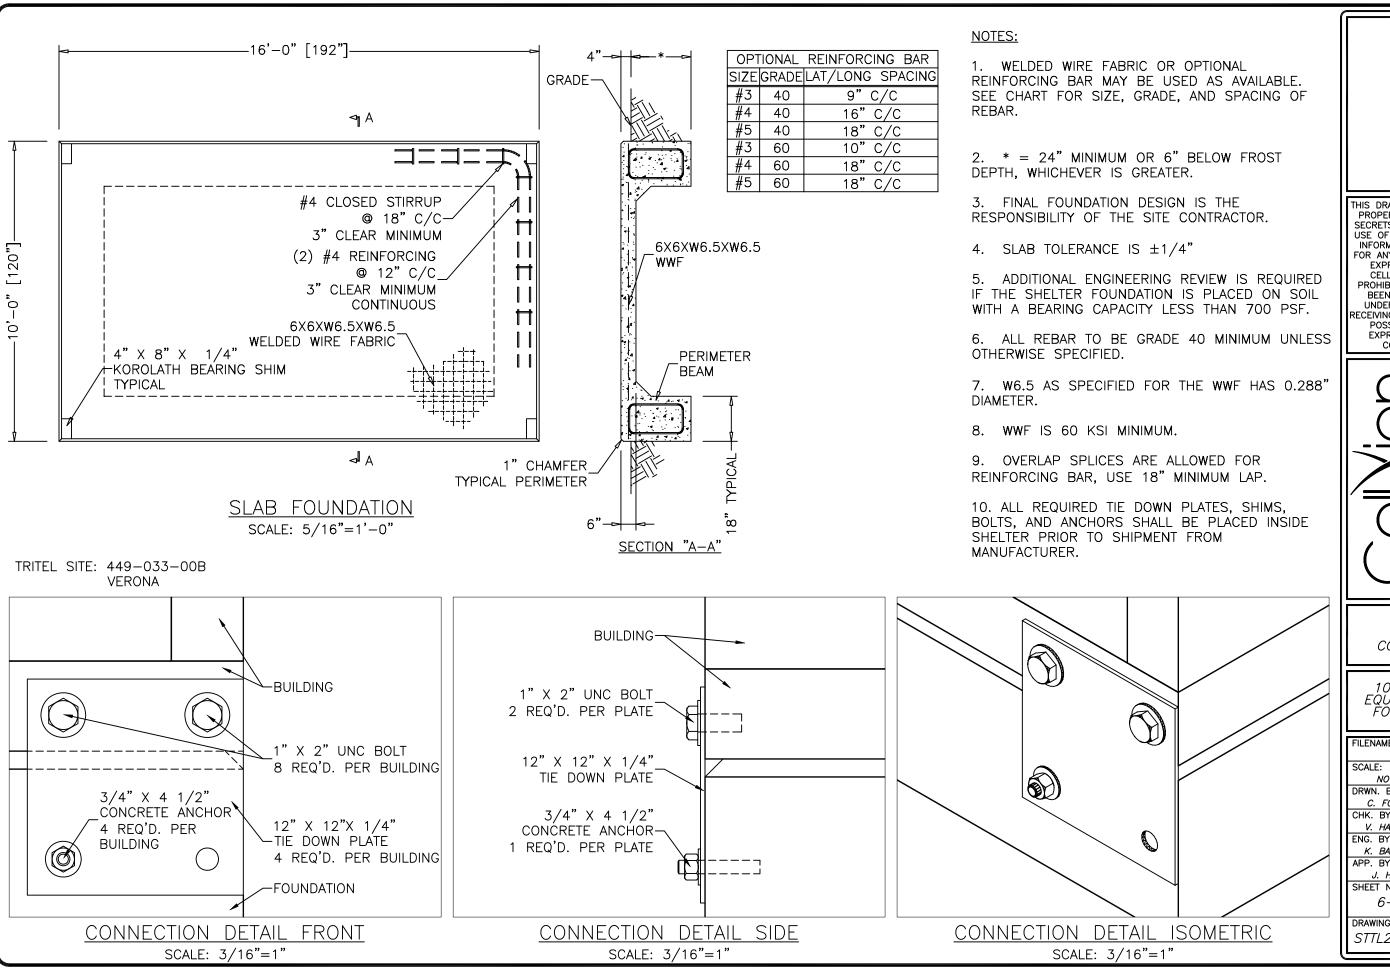

ENGINEER SEAL

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CUSTOMER:

TRITEL COMMUNICATIONS

PROJECT: 10'-0" X 16'-0" EQUIPMENT SHELTER FOUNDATION PLAN TYPE I


FILENAME:		
SCALE: NOTED	TOLERAN	ICE:
DRWN. BY:	DATE:	5/01
CHK. BY: V. HASSELL	DATE: 9/2	
ENG. BY: K. BARNETT	DATE:	5/01
APP. BY: J. HOOD	DATE:	5/01
SHEET NO.: 6-4	PART NO	
DRAWING NO.:		REV:
STTL20		T


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TRITEL PROJECT NO. 210-105-00A

BAY POINT, RANKIN COUNTY MS.

NOTES:



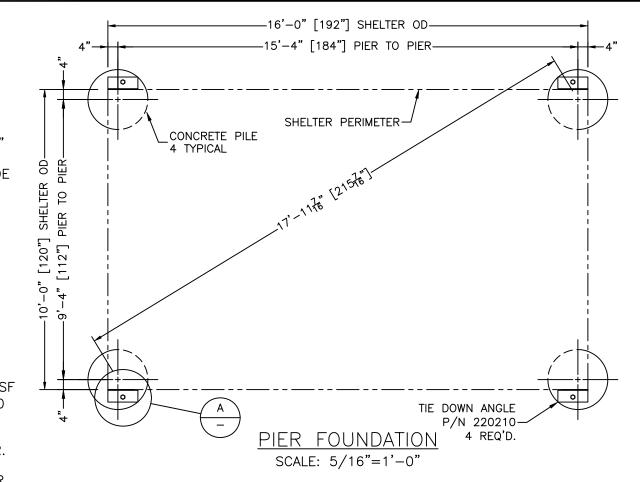
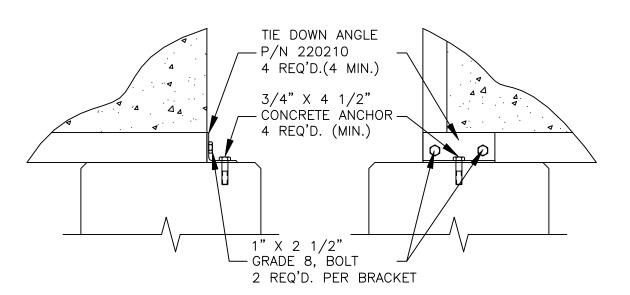
<u>DETAIL "A"</u> SCALE: 3/4"=1'-0"

ENGINEER SEAL

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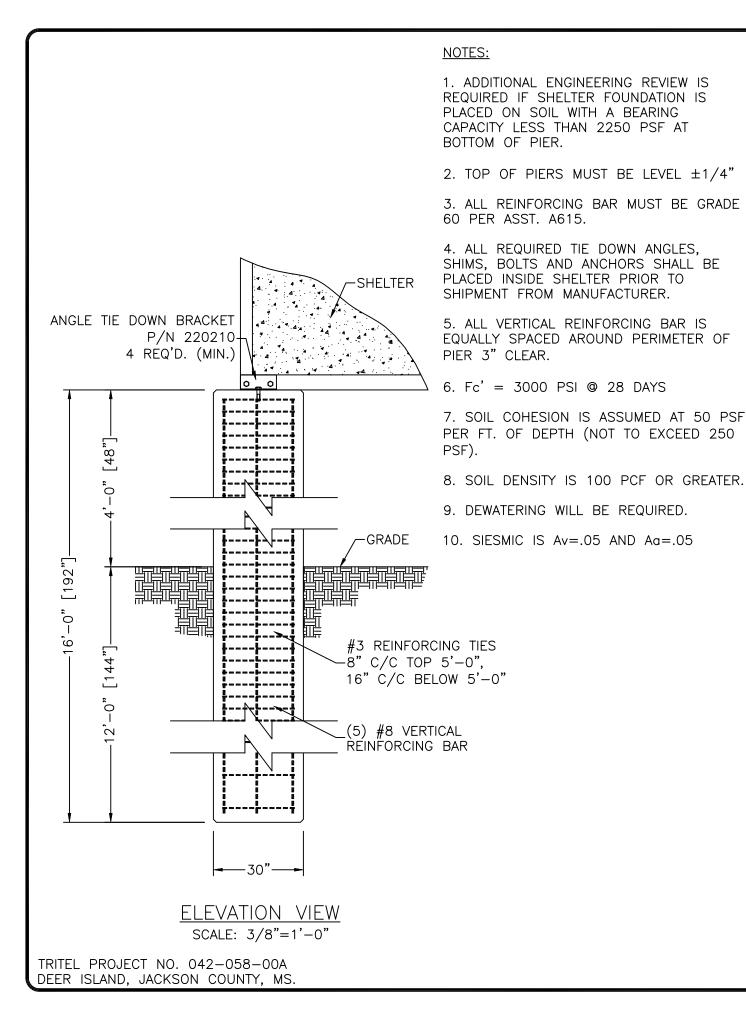



CUSTOMER:


TRITEL

PROJECT: 10'-0" X 16'-0" CONCRETE, SHELTER 22'-6", PIER FOUNDATION, PLAN

FILENAME:		
SCALE:	TOLERAN	ICE:
NOTED	NO	TED
DRWN. BY:	DATE:	
S. MARTIN	12/	4/00
CHK. BY:	DATE:	
V. HASSELL	12/4	4/00
ENG. BY:	DATE:	
K. BARNETT	12/4	4/00
APP. BY:	DATE:	
M. MAYFIELD	12/4	4/00
SHEET NO.:	PART NO).:
6-5		
DRAWING NO.:	•	REV:
STTL20		T



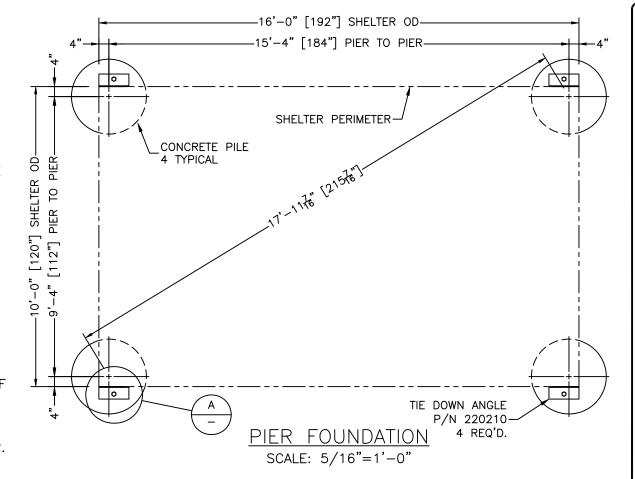

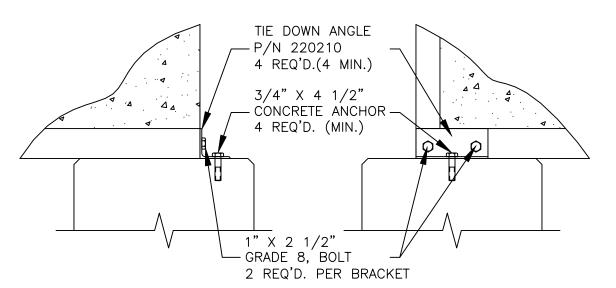

<u>DETAIL</u> "A"

SCALE: 3/4"=1'-0"

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ENGINEER SEAL

UNDERSTANDING THAT ANYONE RECEIVING OR OTHERWISE OBTAINING POSSESSION OF IT WILL BE EXPRESSLY NOTIFIED OF ITS CONFIDENTIAL NATURE.

Solutions for the Mirreless Industry
5031 Hazel Jones Road
Bossier City, Louisiana 7111
voice: (318) 213–2919
fax: (318) 213–2919

CUSTOMER:


TRITEL

PROJECT:
10'-0" X 16'-0"
CONCRETE SHELTER
11'-6" PIER
FOUNDATION PLAN

FILENAME:	
SCALE:	TOLERANCE:
NOTED	NOTED
DRWN. BY:	DATE:
S. MARTIN	12/4/00
CHK. BY:	DATE:
V. HASSELL	12/4/00
ENG. BY:	DATE:
K. BARNETT	12/4/00
APP. BY:	DATE:
M. MAYFIELD	12/4/00
SHEET NO.:	PART NO.:
6-6	
DRAWING NO ·	RFV·

	MATERIAL LIST	
ITEM NO.	DESCRIPTION	PART NO.
1	CABLE TRAY (SIZE VARIES)	VARIES
2	3/8" X 2" LAG SCREW	164263
3	#6 X 1 1/4" GALV. SCREW	168022
4	5/8" SPRING LESS TWIRL NUT	168048
5	5/8" SQ. YELLOW ZINC WASHER	510012
6	5/8" HEX YELLOW ZINC NUT	510013
7	HANGING BRACKET	510011
8	5/8" ALL-THREAD CAP	510021
9	5/8" ZINC PLATED ALL-THREAD	168025
10	3/8" X 2 1/4" BOLT	510010
11	STRAIGHT CLAMP	510010
12	3/8" X 1 1/2" BOLT	510002
13	CORNER CLAMP	510002
14	1/4" X 2 1/4" J-BOLT	510004
15	3/8" FLAT WASHER	168038
16	WALL ANGLE (SIZE VARIES)	VARIES
17	3/8" HEX NUT	168039
18	WALL S CLAMP	510014
19	CLOSING BAR	VARIES
20	1/4" X 1" FENDER WASHER	168052
21		
22		
23		
24		
25		

- 1. PARTS AND DETAILS SHOWN ARE TYPICAL. SOME PARTS AND DETAILS MAY BE OMITTED.
- 2. CABLE TRAY FINISH, SIZES AND LOCATION MAY VARY. REFER TO CEILING VIEW, INTERIOR ELEVATIONS AND/OR ITEM LIST FOR LOCATIONS AND SIZES.
- 3. HANGING BRACKET ASSEMBLY MAY VARY IN LOCATION.
- 4. CLOSING BARS ARE USED TO TERMINATED CABLE TRAY RUN AS REQUIRED.

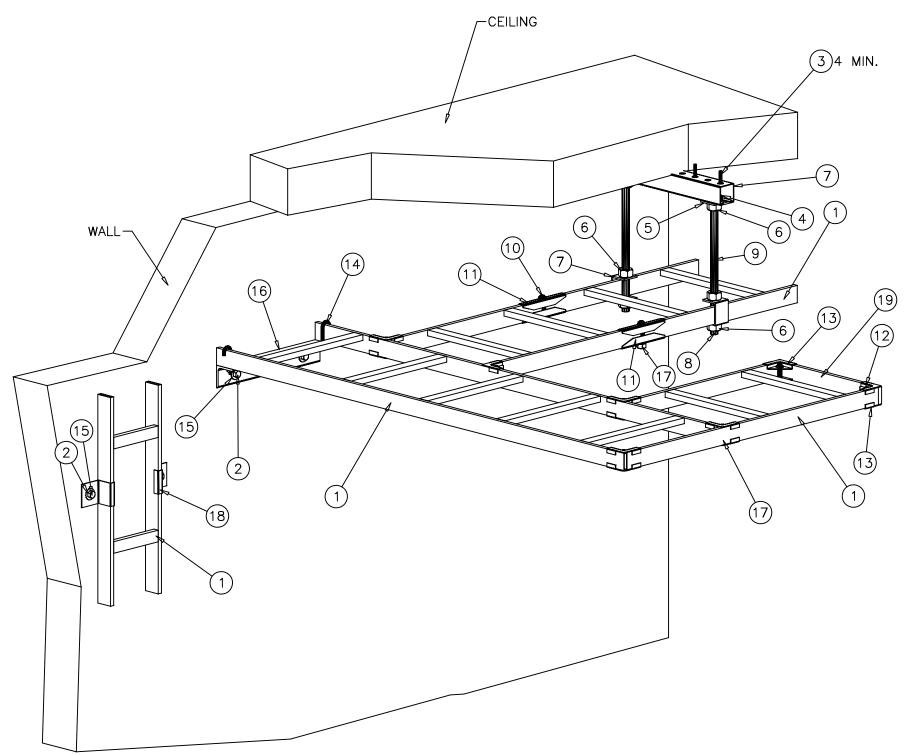

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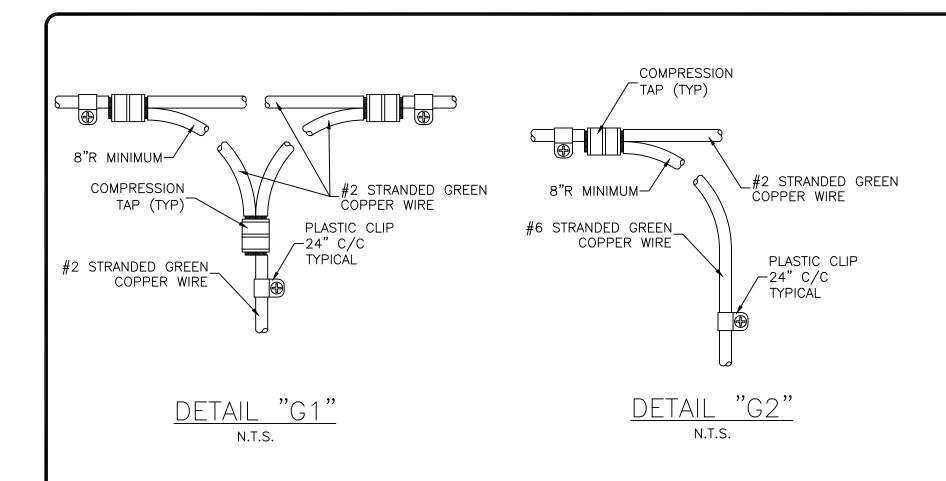



CUSTOMER:


TRITEL COMMUNICATIONS

PROJECT: 10'-0" X 16'-0" EQUIPMENT SHELTER CABLE TRAY DETAILS

١	FILENAME:		
	TTL20\TTL207-0		
	SCALE:	TOLERAN	CE:
	1/8" = 1'-0"		
	DRWN. BY:	DATE:	
	V. HASSELL	11/1	2/99
	CHK. BY:	DATE:	
	V. HASSELL	11/1	2/99
	ENG. BY:	DATE:	
	K. BARNETT	11/1	2/99
	APP. BY:	DATE:	
	M. MAYFIELD	11/1	2/99
	SHEET NO.		
	7-0		
	DRAWING NO.:		
	STTL20		T
	1		, , , , , , , , , , , , , , , , , , ,



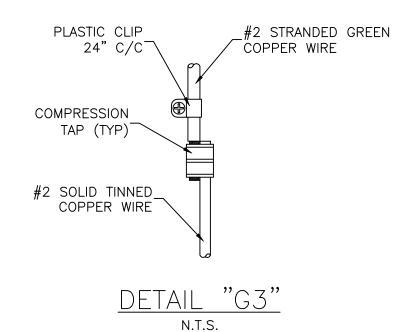

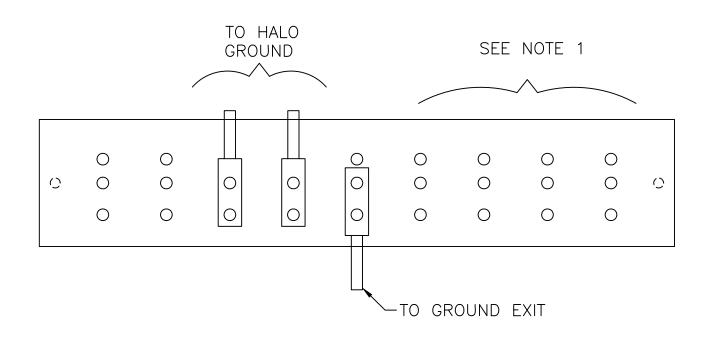

N.T.S.

S MRC 4/18/02 REVISED PRINT: ADDED ITEMS "G3" AND "G4"
REV BY DATE DESCRIPTION

VGH 4/18/02 APP.BY DATE

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CUSTOMER:

TRITEL COMMUNICATIONS

PROJECT: 10'-0" X 12'-0" EQUIPMENT SHELTER HALO GROUND DETAILS

	FILENAME:		
	TTL20\STTL207-1		
	SCALE:	TOLERANCE:	
ı	N.T.S.		
ı	DRWN. BY:	DATE:	
l	M. CROW	4/19/02	
l	CHK. BY:	DATE:	
	V. HASSELL	4/19/02	
	ENG. BY:	DATE:	
	K. BARNETT	4/19/02	
ı	APP. BY:	DATE:	
	M. MAYFIELD	4/19/02	
	SHEET NO.		
l	7—1		
ı	. ,		
•	DDAWING NO		

DRAWING NO.:
STTL20 7

1. GSM RACK GROUNDING TO BE LOCATED TO RIGHT OF

GROUND BAR.

NOTES:

GENERAL NOTES:

- ALL STEEL FABRICATION AND INSTALLATION SHALL BE DONE IN ACCORDANCE WITH THE AMERICAN INSTITUTE OF STEEL CONSTRUCTION MANUAL AND AWS D1.1 SPECIFICATIONS.
- 2.) ALL WELDING SHALL BE MIG TYPE WITH THE FOLLOWING OPERATING SETTINGS.

WIRE SIZE -----0.35 WIRE FEED SPEED (in/min) -----5 VOLTAGE, DC (+) -----18.5 AMPERAGE, DC -----140 TRAVEL SPEED (in/min) -----10-12 SHIELDING GAS ----75/25

3.) STRUCTURAL STEEL SPECIFICATIONS:

STEEL DECK AND COLD FORMED SHAPES ASTM A446 GRADE D STRUCTURAL SHAPES ASTM A36 HIGH STRENGTH BOLTS, ASTM A325 OTHER BOLTS, SAE J429 GRADE 5 STRUCTURAL TUBING ASTM A500 GRADE B

- 4.) ALL CONCRETE WORK SHALL CONFORM TO AMERICAN CONCRETE INSTITUTE (A.C.I.) BUILDING CODES 318 & 211, AND ASTM STANDARDS C-172, C-31, C-39, AND PROVISIONS OF C-94.
- ALL PRECAST STRUCTURAL LIGHTWEIGHT CONCRETE SHALL HAVE A MINIMUM COMPRESSIVE STRENGTH OF 5000 PSI AT 28 DAYS.
- ALL REINFORCING STEEL BARS SHALL BE DOMESTIC, NEW BILLET STEEL CONFORMING TO ASTM A-615 GRADE 60 SPECIFICATIONS.
- 7.) CONCRETE COVERAGE OVER ALL REINFORCING STEEL SHALL BE A MINIMUM OF 3/4".
- ALL REBAR SHALL BE TIED 100% AT THE PERIMETER, AND 50% ELSEWHERE.
- 9.) ALL REBAR WIRE TIES TO BE 16 GUAGE.
- 10.) FIBROUS REINFORCED LIGHTWEIGHT CONCRETE MAY BE USED IN THE ROOF AND SHALL HAVE A MINIMUM COMPRESSIVE STRENGTH OF 5000 PSI AT 28 DAYS.
 FIBER REINFORCEMENT MAY BE USED IN THE FLOOR IF DESIRED. IN ORDER TO MAKE BATCHING OPERATION MORE EFFICIENT.
- 11.) CELLXION CONCRETE EQUIPMENT SHELTERS ARE DESIGNED TO CONTAIN COMMUNICATION EQUIPMENT AND ARE INTENDED TO BE UNMANNED.
- 12.) WELD PLATE CONNECTIONS SHALL BE SPACED AT 4'-8" MAXIMUM ON THE FLOOR AND ROOF PANELS. THIS DIMENSION SHALL BE MAINTAINED EXCEPT IN CASES WHERE OPENINGS PROHIBIT.
- 13.) TOLERANCES SHALL BE AS FOLLOWS: PANEL THICKNESS - ±1/8" PANEL SIZE - ±1/16" PANEL SQUARENESS $-\pm 1/8$ " AGREEMENT ON DIAGONALS LOCATION OF BLOCKOUTS & PVC'S - ±1/4" BLOCKOUT DIMENSIONS - +1/4", -0" PVC SIZE - USE TRADE SIZE AS LISTED ON PROJECT DRAWINGS
- 14.) SECTIONS & DETAILS MAY BE FOUND ON THE FOLLOWING SHEETS.

GENERAL: THESE REBAR SIZES AND SPACINGS REPRESENT THE MINIMUM AMOUNT FOR ALL CASTING PLANS. PROJECT DRAWINGS MAY

REQUIRE REINFORCEMENT IN ADDITION TO CELLXION STANDARDS.

ROOF PANEL: #4 (SHORT AXIS) 12" O.C. AND #4 (LONG AXIS) AT 18" O.C. #4 AT PERIMETER AND 4x4-W4.5xW4.5 MESH THROUGHOUT. WALL PANEL:


WALL OPENNINGS: SEE DETAIL P & Q (SHEET NO. 6)


(2)-#6 (SHORT AXIS) EACH RIB, #6 (LONG AXIS) EACH RIB AND AT PERIMETER. DECK: 4x4-W4.5xW4.5 MESH. FLOOR:

WELD PLATES : 1/4"x3"x3". A36 STEEL.

SEALANT APPLICATION

- STEP 1. URETHANE SEALANT REQUIRED ON ALL JOINTS.
- STEP 2. ROOF MEMBRANE APPLY SEALER TO ROOF PER MFG. DIRECTIONS. USE 1 GALLON PER 70 SQ. FEET.
- STEP 3. APPLY AGGREGATE SEALER TO EXTERIOR WALLS. USE 1 GALLON PER 200 SQ. FEET.
- USE TEXTURED SEALER ON ALL SMOOTH EXPOSED SURFACES. USE CEMENTITOUS GRAY PAINT.

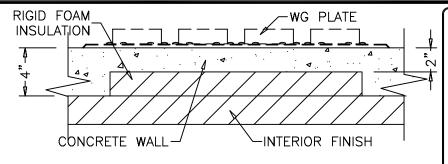

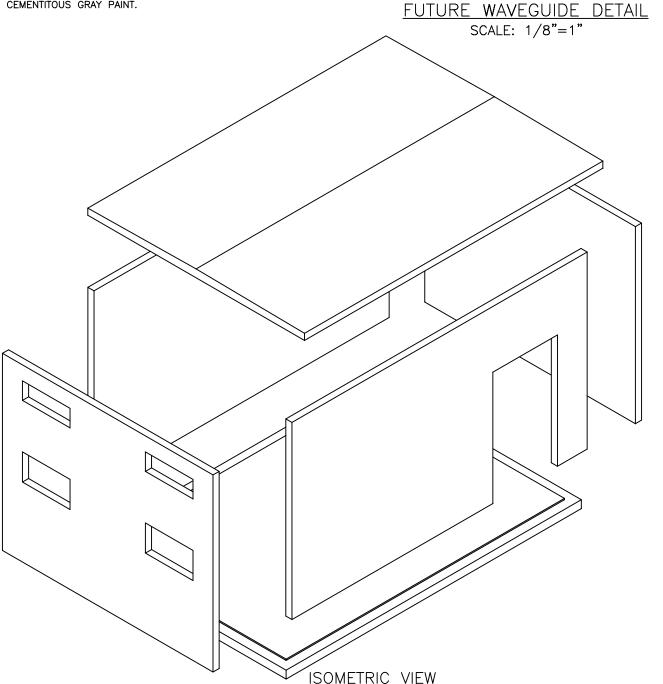

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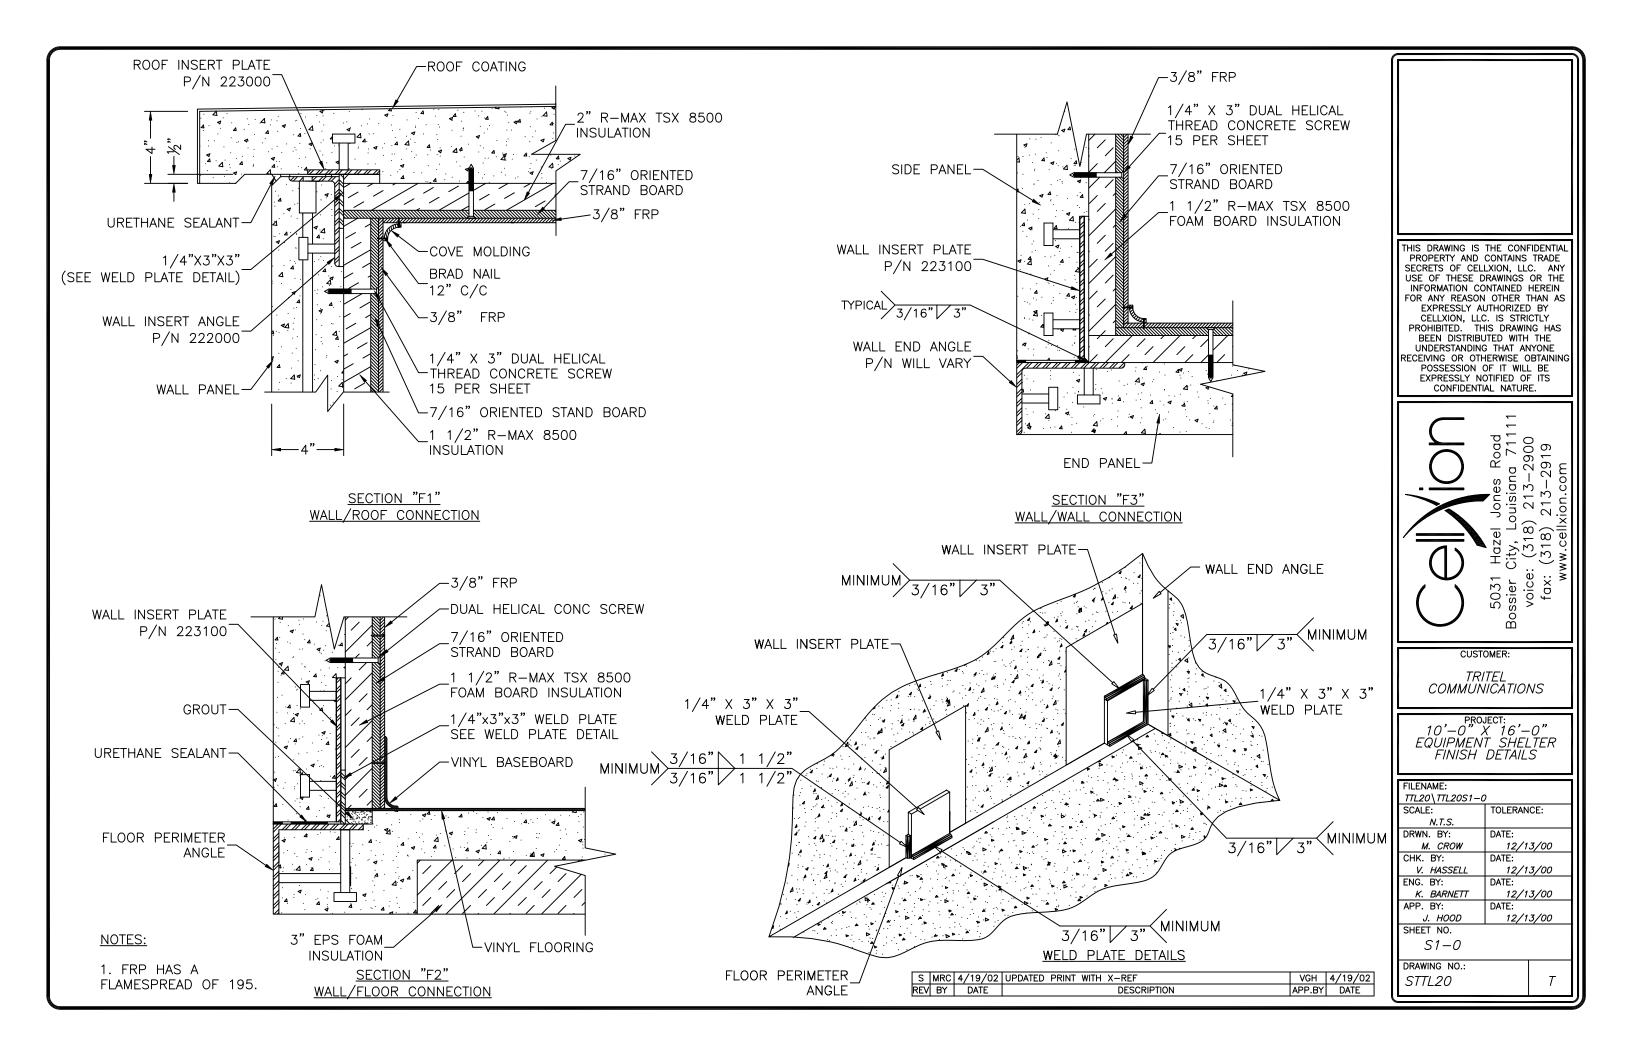



CUSTOMER:

TRITEL COMMUNICATIONS


PROJECT: 10'-0" X 16'-0" EQUIPMENT SHELTER STRUCTURAL SPECIFICATIONS

	FILENAME:		
1	FILENAME:		
ı	TTL20\TTL20S0-0		
ı	SCALE:	TOLERANCE:	
	N.T.S.		
ı	DRWN. BY:	DATE:	
ı	V. HASSELL	11/12/99	
ı	CHK. BY:	DATE:	
ı	V. HASSELL	11/12/99	
ı	ENG. BY:	DATE:	
ı	K. BARNETT	11/12/99	
ı	APP. BY:	DATE:	
ı	M. MAYFIELD	11/12/99	
ı	SHEET NO.		
ı	S0-0		
	30 0		
1	DRAWING NO.:		



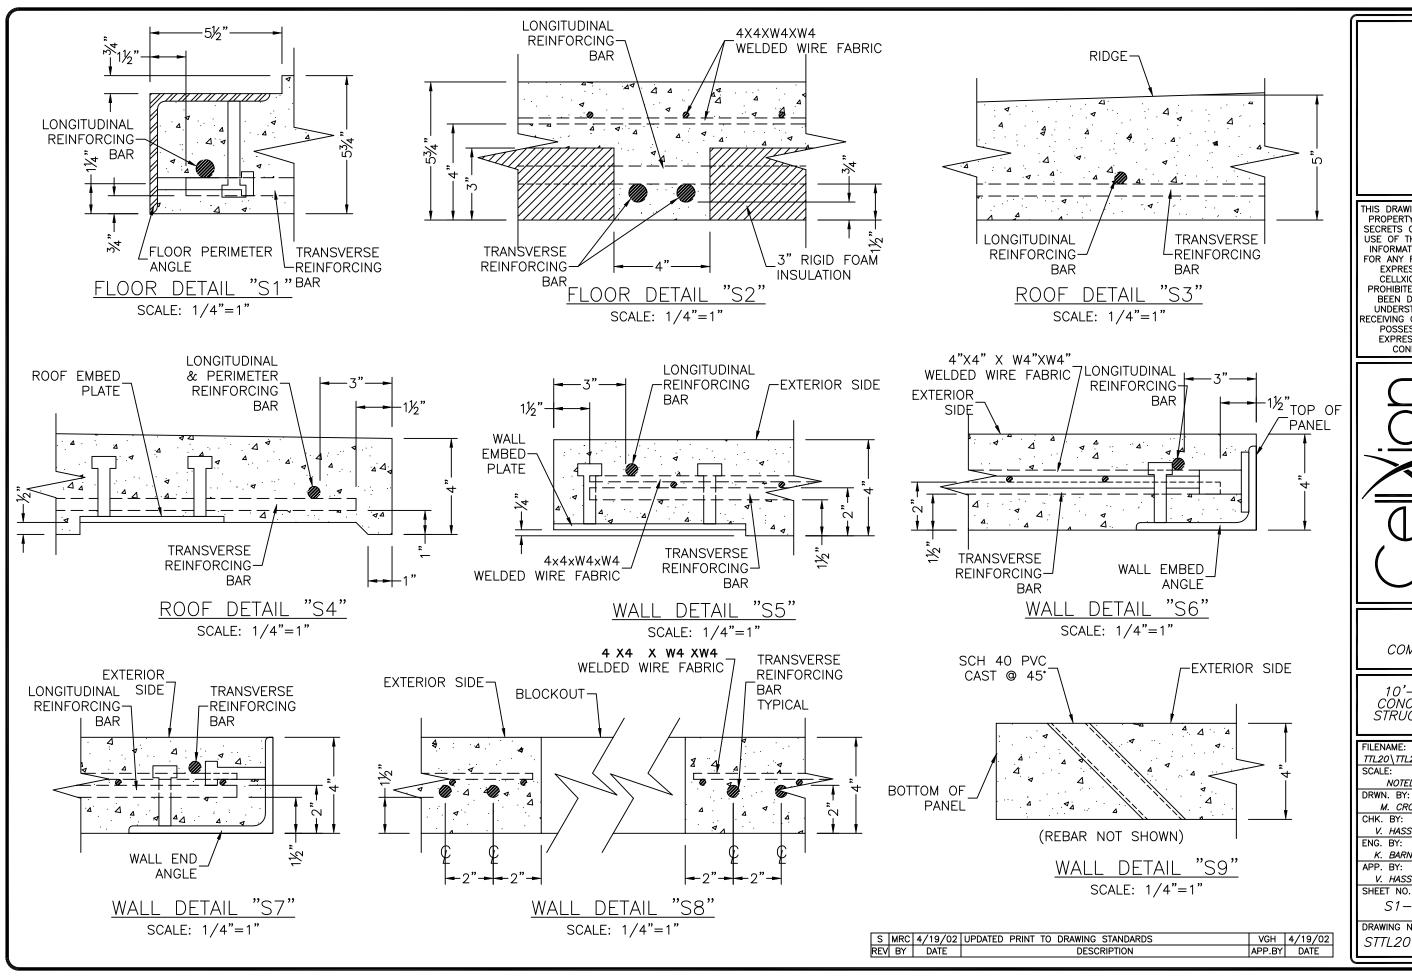

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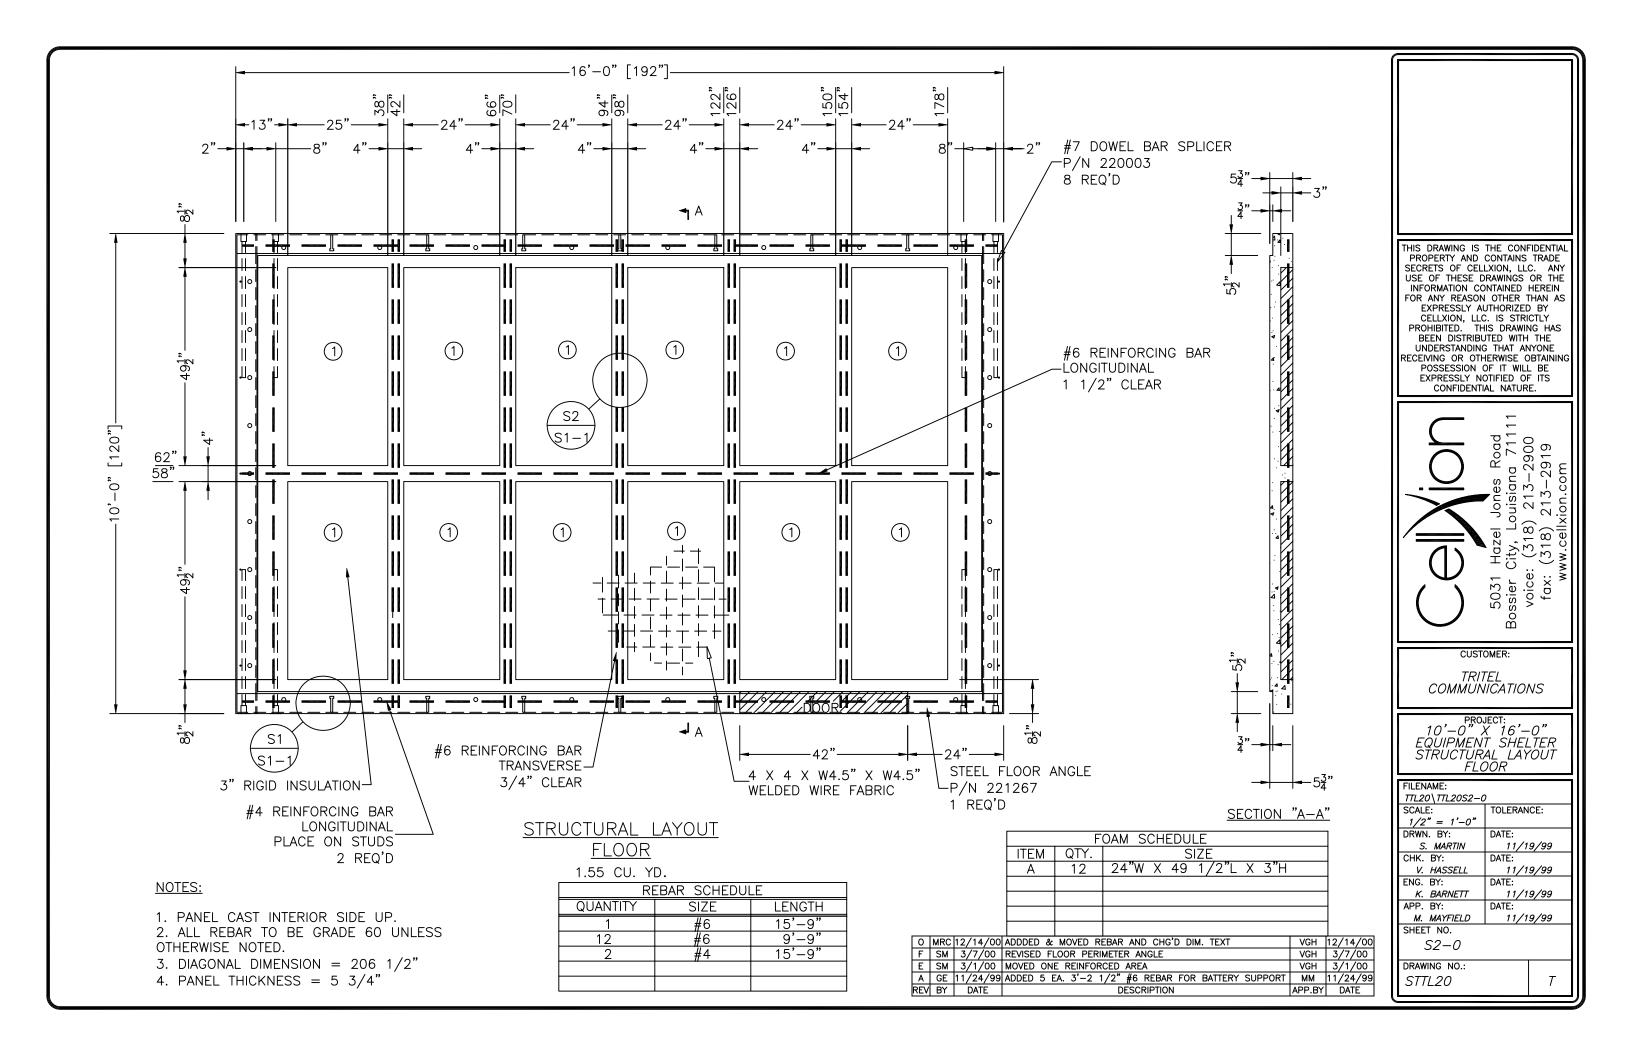


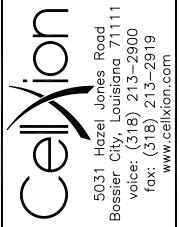
CUSTOMER:

TRITEL COMMUNICATIONS

PROJECT: 10'-0" X 16'-0" CONCRETE SHELTER STRUCTURAL DETAILS

FILENAME:		
TTL20\TTL20S1-1		
SCALE:	TOLERANCE:	
NOTED		
DRWN. BY:	DATE:	
M. CROW	12/13/00	
CHK. BY:	DATE:	
V. HASSELL	12/13/00	
ENG. BY:	DATE:	
K. BARNETT	12/13/00	
APP. BY:	DATE:	
V. HASSELL	12/13/00	
SHEET NO.		
S1-1		
0, ,		
DRAWING NO.:		
CTT/ CC	-	



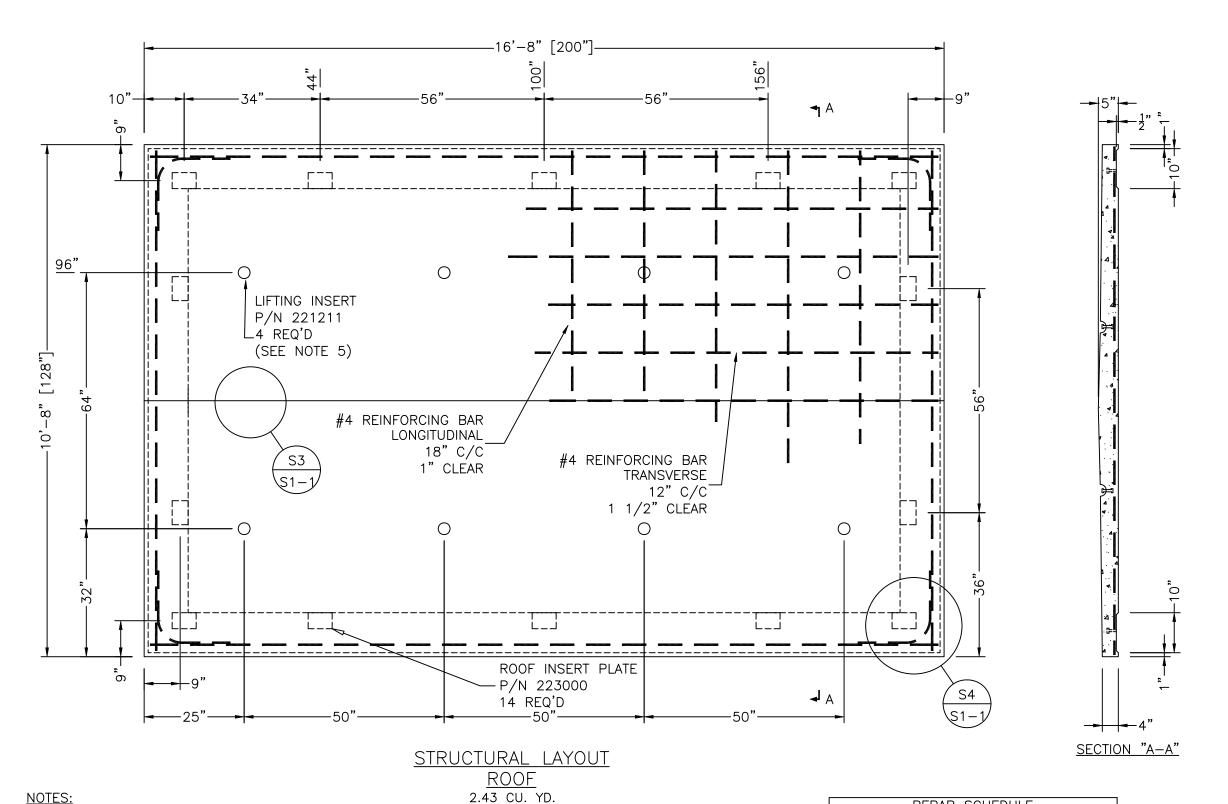

1. PANEL CAST EXTERIOR SIDE UP.

2. DIAGONAL DIMENSION = 222 3/4"

3. ALL REBAR TO BE GRADE 60 UNLESS OTHERWISE NOTED.

4. PANEL THICKNESS = 4", EAVE, 5" RIDGE.

5. REFER TO DAYTON SUPERIOR CATALOG FOR PART #D-52-SL

REBAR SCHEDULE				
QUANTITY	SIZE	LENGTH		
12	4	16'-5"		
11	4	10'-5"		
4	4-CORNER	3'-0"		

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CONFIDENTIAL NATURE.





CUSTOMER:

TRITEL COMMUNICATIONS

PROJECT: 10'-0" X 16'-0" EQUIPMENT SHELTER STRUCTURAL LAYOUT ROOF

- 1				
l	FILENAME: <i>ΠL20\ΠL20S3-0</i>			
l	SCALE: $1/2" = 1'-0"$	ICE:		
l	DRWN. BY: S. MARTIN	DATE: 11/1	9/99	
l	CHK. BY: V. HASSELL	DATE:	9/99	
l	ENG. BY: K. BARNETT	DATE: 11/19/99 DATE:		
l	APP. BY: M. MAYFIELD			
	SHEET NO. S3-0	,	•	
	DRAWING NO.: STTL20		Т	

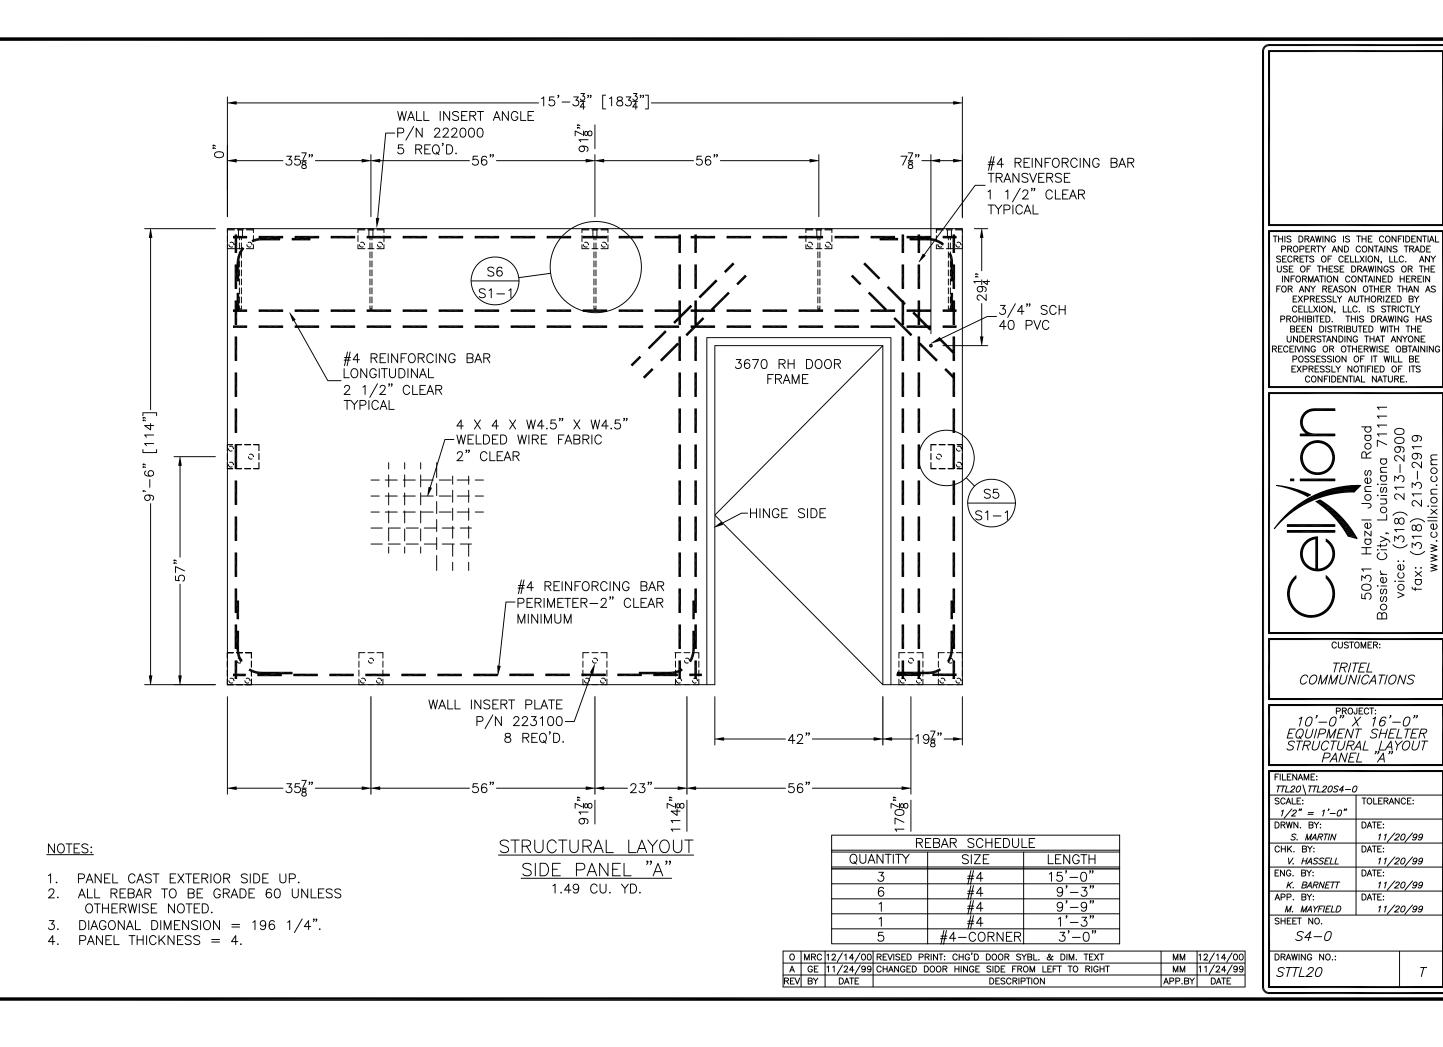

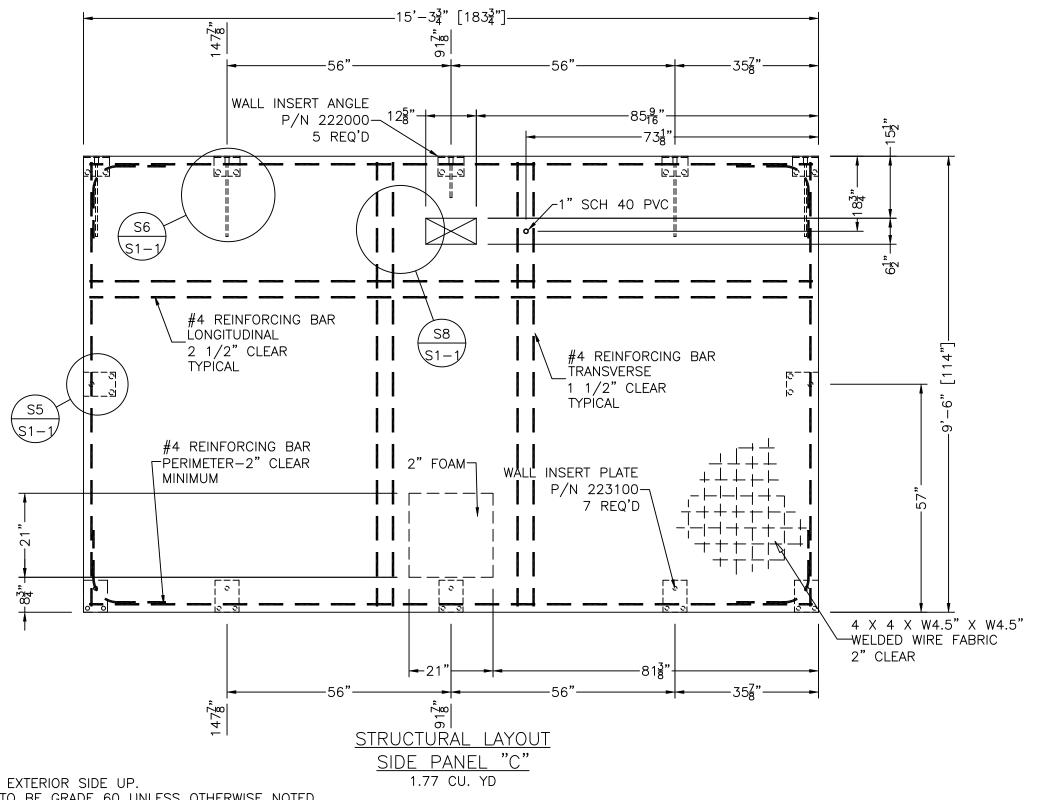

1. PANEL CAST EXTERIOR SIDE UP.

- 2. ALL REBAR TO BE GRADE 60 UNLESS OTHERWISE NOTED.
- 3. DIAGONAL DIMENSION = 216 1/4".
- 4. PANEL THICKNESS = 4".

REBAR SCHEDULE				
QUANTITY	SIZE	LENGTH		
4	4	15'-0"		
6	4	9'-3"		
4	4-CORNER	3'-0"		

R	MRC	8/28/01	REVISED PRINT: ADDED WELED WIRE FABRIC	VGH	8/28/01
0	MRC	12/14/00	REVISED PRINT: CUT OFF EMBED & CHG'D DIM. TEXT	VGH	12/14/00
Н	GE	4/10/00	REMOVED: ITEM 5 (MICROFLECT WAVEGUIDE) AND NOTE 5;	VGH	4/10/00
			CHG'D.: OPENING WAS 12 1/2" WIDE		
E	SM	3/1/00	REMOVED LOWER ROXTEC BLOCK OUT	VGH	3/1/00
С	SM	2/2/00	ADDED 1" PVC	VGH	2/2/00
В	SM	1/06/00	CHANGES MADE PER REVIEW OF PROTOTYPE BY CUSTOMERS	VGH	1/06/00
Α	VGH	12/3/99	3/99 REVISED PRINT; CHANGED B/O SIZE		12/3/99
REV	BY	DATE	DESCRIPTION		DATE

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CONFIDENTIAL NATURE.




CUSTOMER:

TRITEL COMMUNICATIONS

PROJECT: 10'-0" X 16'-0" EQUIPMENT SHELTER STRUCTURAL LAYOUT PENEL "C"

1
TOLERANCE:
DATE:
11/20/99

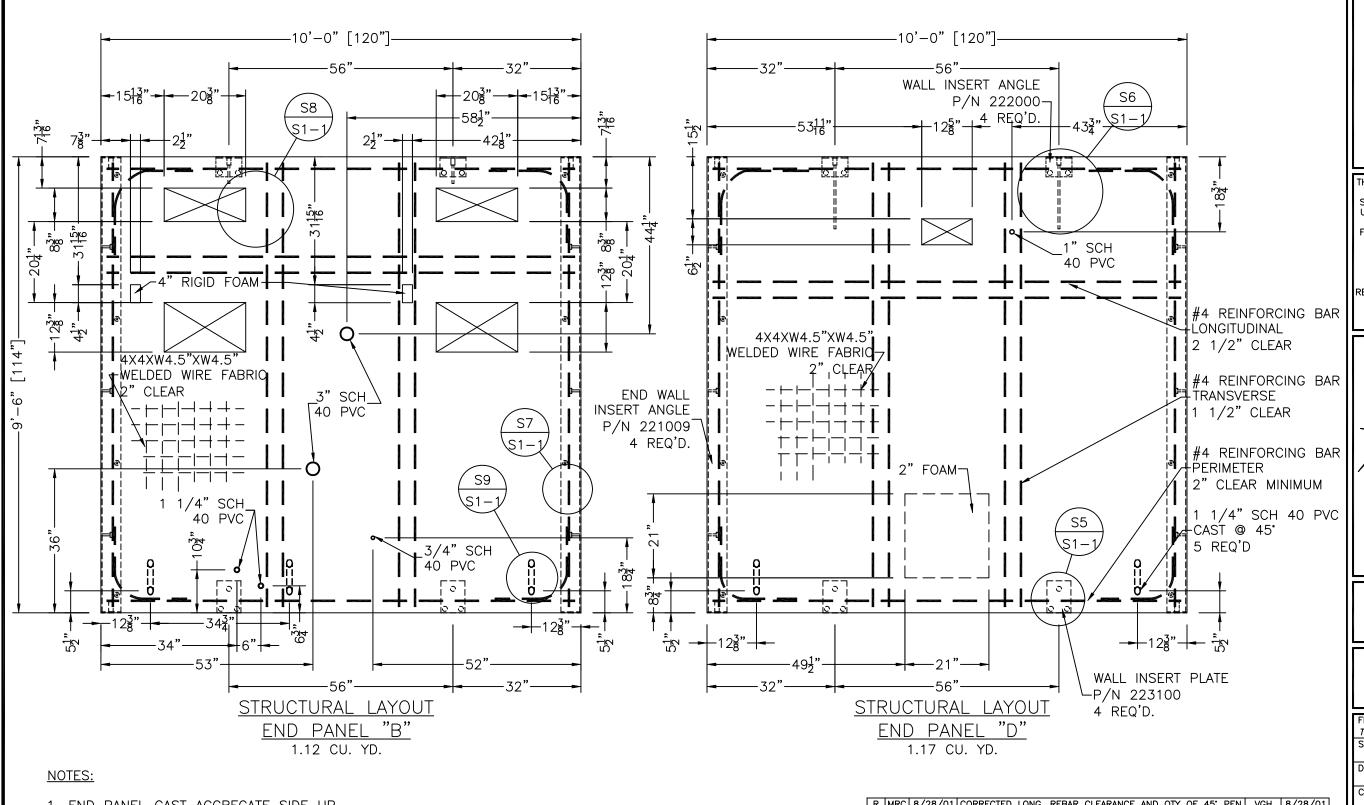

- 1. END PANEL CAST AGGREGATE SIDE UP.
- 2. ALL REBAR TO BE GRADE 60 UNLESS OTHERWISE NOTED
- 3. PANEL THICKNESS = 4"
- 4. DIAGONAL DIMENSION = $165 \ 1/2$ "

REBAR SCHEDULE				
QUANTITY	LENGTH			
8	4	9'-9"		
11	4	9'-3"		
8	4-CORNER	3'-0"		

R	MRC	8/28/01	CORRECTED LONG. REBAR CLEARANCE AND QIY OF 45 PEN.	VGH	8/28/01
0	MRC	12/14/00	REVISED PRINT: CUT EMBEDS & CHG'D DIM. TEXT		12/14/00
L	CTF	10/18/00	ADDED PENETERTION	VGH	10/18/00
Н	GE	4/10/00	REMV'D.: ITEM #5 (MICROFLECT WAVEGUIDE) AND NOTE #5;	VGH	4/10/00
			CHG'D.: OPENING WAS 12 1/2" WIDE; ADDED: 4" RIGID		
			FOAM FOR A/C		
Ε	SM	3/1/00	REMOVED LOWER ROXTEC BLOCK OUT	VGH	3/1/00
С	GE	1/27/00	MOVED SERV. ENT.; ADDED 1" PVC; CHG'D 1" PVC TO 1 1/	4"VGH	1/27/00
В	SM	1/06/00	CHANGES MADE PER REVIEW OF PROTOTYPE BY CUSTOMER	VGH	1/06/00
Α	VGH	12/9/99	REVISED PRINT; CHANGED B/O SIZE	VGH	12/9/99
REV	BY	DATE	DESCRIPTION	APP.BY	DATE
				•	•

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CUSTOMER:

TRITEL COMMUNICATIONS

PROJECT: 10'-0" X 16'-0" EQUIPMENT SHELTER STRUCTURAL LAYOUT PANELS "B & D"

FILENAME:			
TTL20\TTL20S4-2			
SCALE:	SCALE: TOLERAN		
1/2" = 1'-0"			
DRWN. BY:	DATE:		
S. MARTIN	11/2	0/99	
CHK. BY:	DATE:		
V. HASSELL	0/99		
ENG. BY:	DATE:		
K. BARNETT	11/2	0/99	
APP. BY:	DATE:		
M. MAYFIELD	11/2	0/99	
SHEET NO.			
54-2			
DRAWING NO.:			
STTL20		T	
1			